





SITE NAME: GIRD ROAD


DRAWING INDEX	DIRECTIONS		DEVELOPMENT SUMMARY				
T01 TITLE SHEET 5 A01 SITE PLAN 5 A02 PARTIAL ENLARGED SITE PLAN 5 A03 ELEVATIONS 5 A04 ELEVATIONS 5 C01 BMP PLAN 5 C02 IMPERVIOUS AREA PLAN 5 L01 LANDSCAPING PLAN 5 LS1 TOPOGRAPHIC SURVEY D		FROM TELESPAN COMMUNICATIONS, LLC OFFICE: 1. DEPART STATE ST TOWARD N LA CUMBRE RD 2. TURN LEFT ONTO S LA CUMBRE RD 3. TAKE RAMP LEFT AND FOLLOW SIGNS FOR US—101 SOUTH 4. KEEP LEFT ONTO CA—134 E 5. KEEP STRAIGHT ONTO I—210 E 6. AT EXIT 45, TAKE RAMP RIGHT FOR CA—57 SOUTH TOWARD SANTA ANA 7. AT EXIT 22C, TAKE RAMP RIGHT FOR CA—71 TOWARD CORONA 8. TAKE RAMP FOR CA—91 E 9. TAKE RAMP RIGHT FOR I—15 SOUTH TOWARD SAN DIEGO 10. AT EXIT 46, TAKE RAMP RIGHT FOR CA—76 TOWARD PALA / OCEANSIDE 11. TURN RIGHT ONTO CA—76 / PALA RD 12. TURN RIGHT ONTO GIRD RD 13. TURN RIGHT ONTO DIEGO ESTATES DR 14. ARRIVE AT DIEGO ESTATES DR		PROJECT SCOPE OF WORK: THIS PROJECT ENTAILS THE INSTALLATION OF: 1. (2) CO-LOCATABLE 55'H MONO-BROADLEAF 2. EQUIPMENT AREA FOR (3) CARRIERS & (2) MONO-BROADLEAF: - MONO-BROADLEAF "A" & EQUIPMENT LEASE AREA: 2280 SQ. FT. - MONO-BROADLEAF "B" LEASE AREA: 361 SQ. FT. - TOTAL LEASE AREA: 2641 SQ. FT. - MAX. EQUIPMENT ENCLOSURE HEIGHT: 10' ABOVE CONCRETE FOUNDATION 3. 900 FEET LONG FOR POWER & TELCO TRENCHING 4. NO NEW LANDSCAPING PROPOSED TOTAL LOT AREA: 278,812 SQ. FT. TOTAL EXISTING IMPERVIOUS AREA: 6585 SQ. FT. TOTAL NEW IMPERVIOUS AREA: 2733 SQ. FT.			
LS2 TOPOGRAPHIC SURVEY LS3 TOPOGRAPHIC SURVEY LS4 TOPOGRAPHIC SURVEY	D D D	DIEGO ESTATES DR.	VICINITY MAP SITE LOCATION		PROPERTY INFORMATION: LEGAL DESCRIPTION: SUBD: RANCHO DIEGO UNTI #1 PM04269 PAR 4 PARCEL "A": METES AND BOUNDS LEGAL DESCRIPTION OF SITE AND BOTH TOWERS (ALL TOGETHER IS FINE). PARCEL "B": METES AND BOUNDS LEGAL DESCRIPTION OF ACCESS FROM PUBLIC ROW TO SITE; PARCEL "C": METES AND BOUNDS LEGAL DESCRIPTION OF UTILITY ROUTE FROM LAST POLE ON DIEGO ESTATES TO SITE; ASSESSOR PARCEL NUMBER: 124-340-21-00 LEASE AREA: 2641 SQ. FT. BUILDING CODE INFORMATION: PROPOSED STRUCTURE:	PROPERTY OWNER: OWNER: GREENWOOD TRUST ADDRESS: 3552 DIEGO ESTATES DR. FALLBROOK, CA 92028 PROJECT OWNER/APPLICANT: TELESPAN COMMUNICATIONS, LLC 3888 STATE ST. SUITE 204 SANTA BARBARA, CA 93105 CONTACT: TIM COTTER PHONE: (805) 451-6283 ZONING INFORMATION: JURISDICTION: COUNTY OF SAN DIEGO	
TODE COMPLIANCE *** NOTE: ALL WORK AND MATERIALS SHALL BE PERFORMED AND INSTALLED IN ACCORDANCE WITH THE CURRENT EDITIONS OF THESE CODES. NOTHING IN THESE PLANS IS TO BE CONSTRUED TO PERMIT WORK NOT CONFORMING TO THESE CODES. 1. 2016 CALIFORNIA ADMINISTRATIVE CODE (CAC) 2. 2016 CALIFORNIA BUILDING CODE (CBC), VOLUMES 1, AND 2 3. 2016 CALIFORNIA ELECTRICAL CODE 4. 2016 CALIFORNIA ENERGY CODE 6. 2016 CALIFORNIA ENERGY CODE 6. 2016 CALIFORNIA FIRE CODE (CFC) 7. 2016 CALIFORNIA GREEN CODE 8. 2016 CALIFORNIA REFERENCES STANDARDS CODE		FALLBROOK 15		OCCUPANCY = U (TELECOMMUNICATION) CONSTRUCTION TYPE = V-B SPRINKLER SYSTEM = N/A PROJECT TEAM: CONSTRUCTION: TIM HENION PHONE: (503) 519-8591 SITE ACQUISITION: TIM HENION PHONE: (503) 519-8591 PLANNING: (503) 519-8591 PLANNING: TIM HENION PHONE: (503) 519-8591 ARCHITECT: D.K. DO, RA PHONE: (949) 475-1000	SW POLE: LATITUDE: N 33'19'41.19" LONGITUDE: W 117'11'04.61" NE POLE: LATITUDE: N 33'19'41.45" LONGITUDE: W 117'11'03.92" TOP OF (N) STRUCTURE (SW POLE): 55' AGL BASE OF STRUCTURE: 480' (A.M.S.L.) TOP OF (N) STRUCTURE (NE POLE): 55' AGL BASE OF STRUCTURE: 490' (A.M.S.L.)		
Telespan DePratti Inc.	3	GIRD ROAD 552 DIEGO ESTATES DRIVE FALLBROOK, CA 92028	DCI PACIFIC A E C WORKS ARCHITECTURE ENGINEERING CONSULTING 32 EXECUTIVE PARK SUITE 110 IRVINE CA 92614		4 12/06/16 INCORPORATE PLANNING & DEVELOPMENT COMMENTS HH BO 3 09/12/16 INCORPORATE COMMUNITY PLANNING COMMENTS HH BO	TITLE SHEET TO 1	

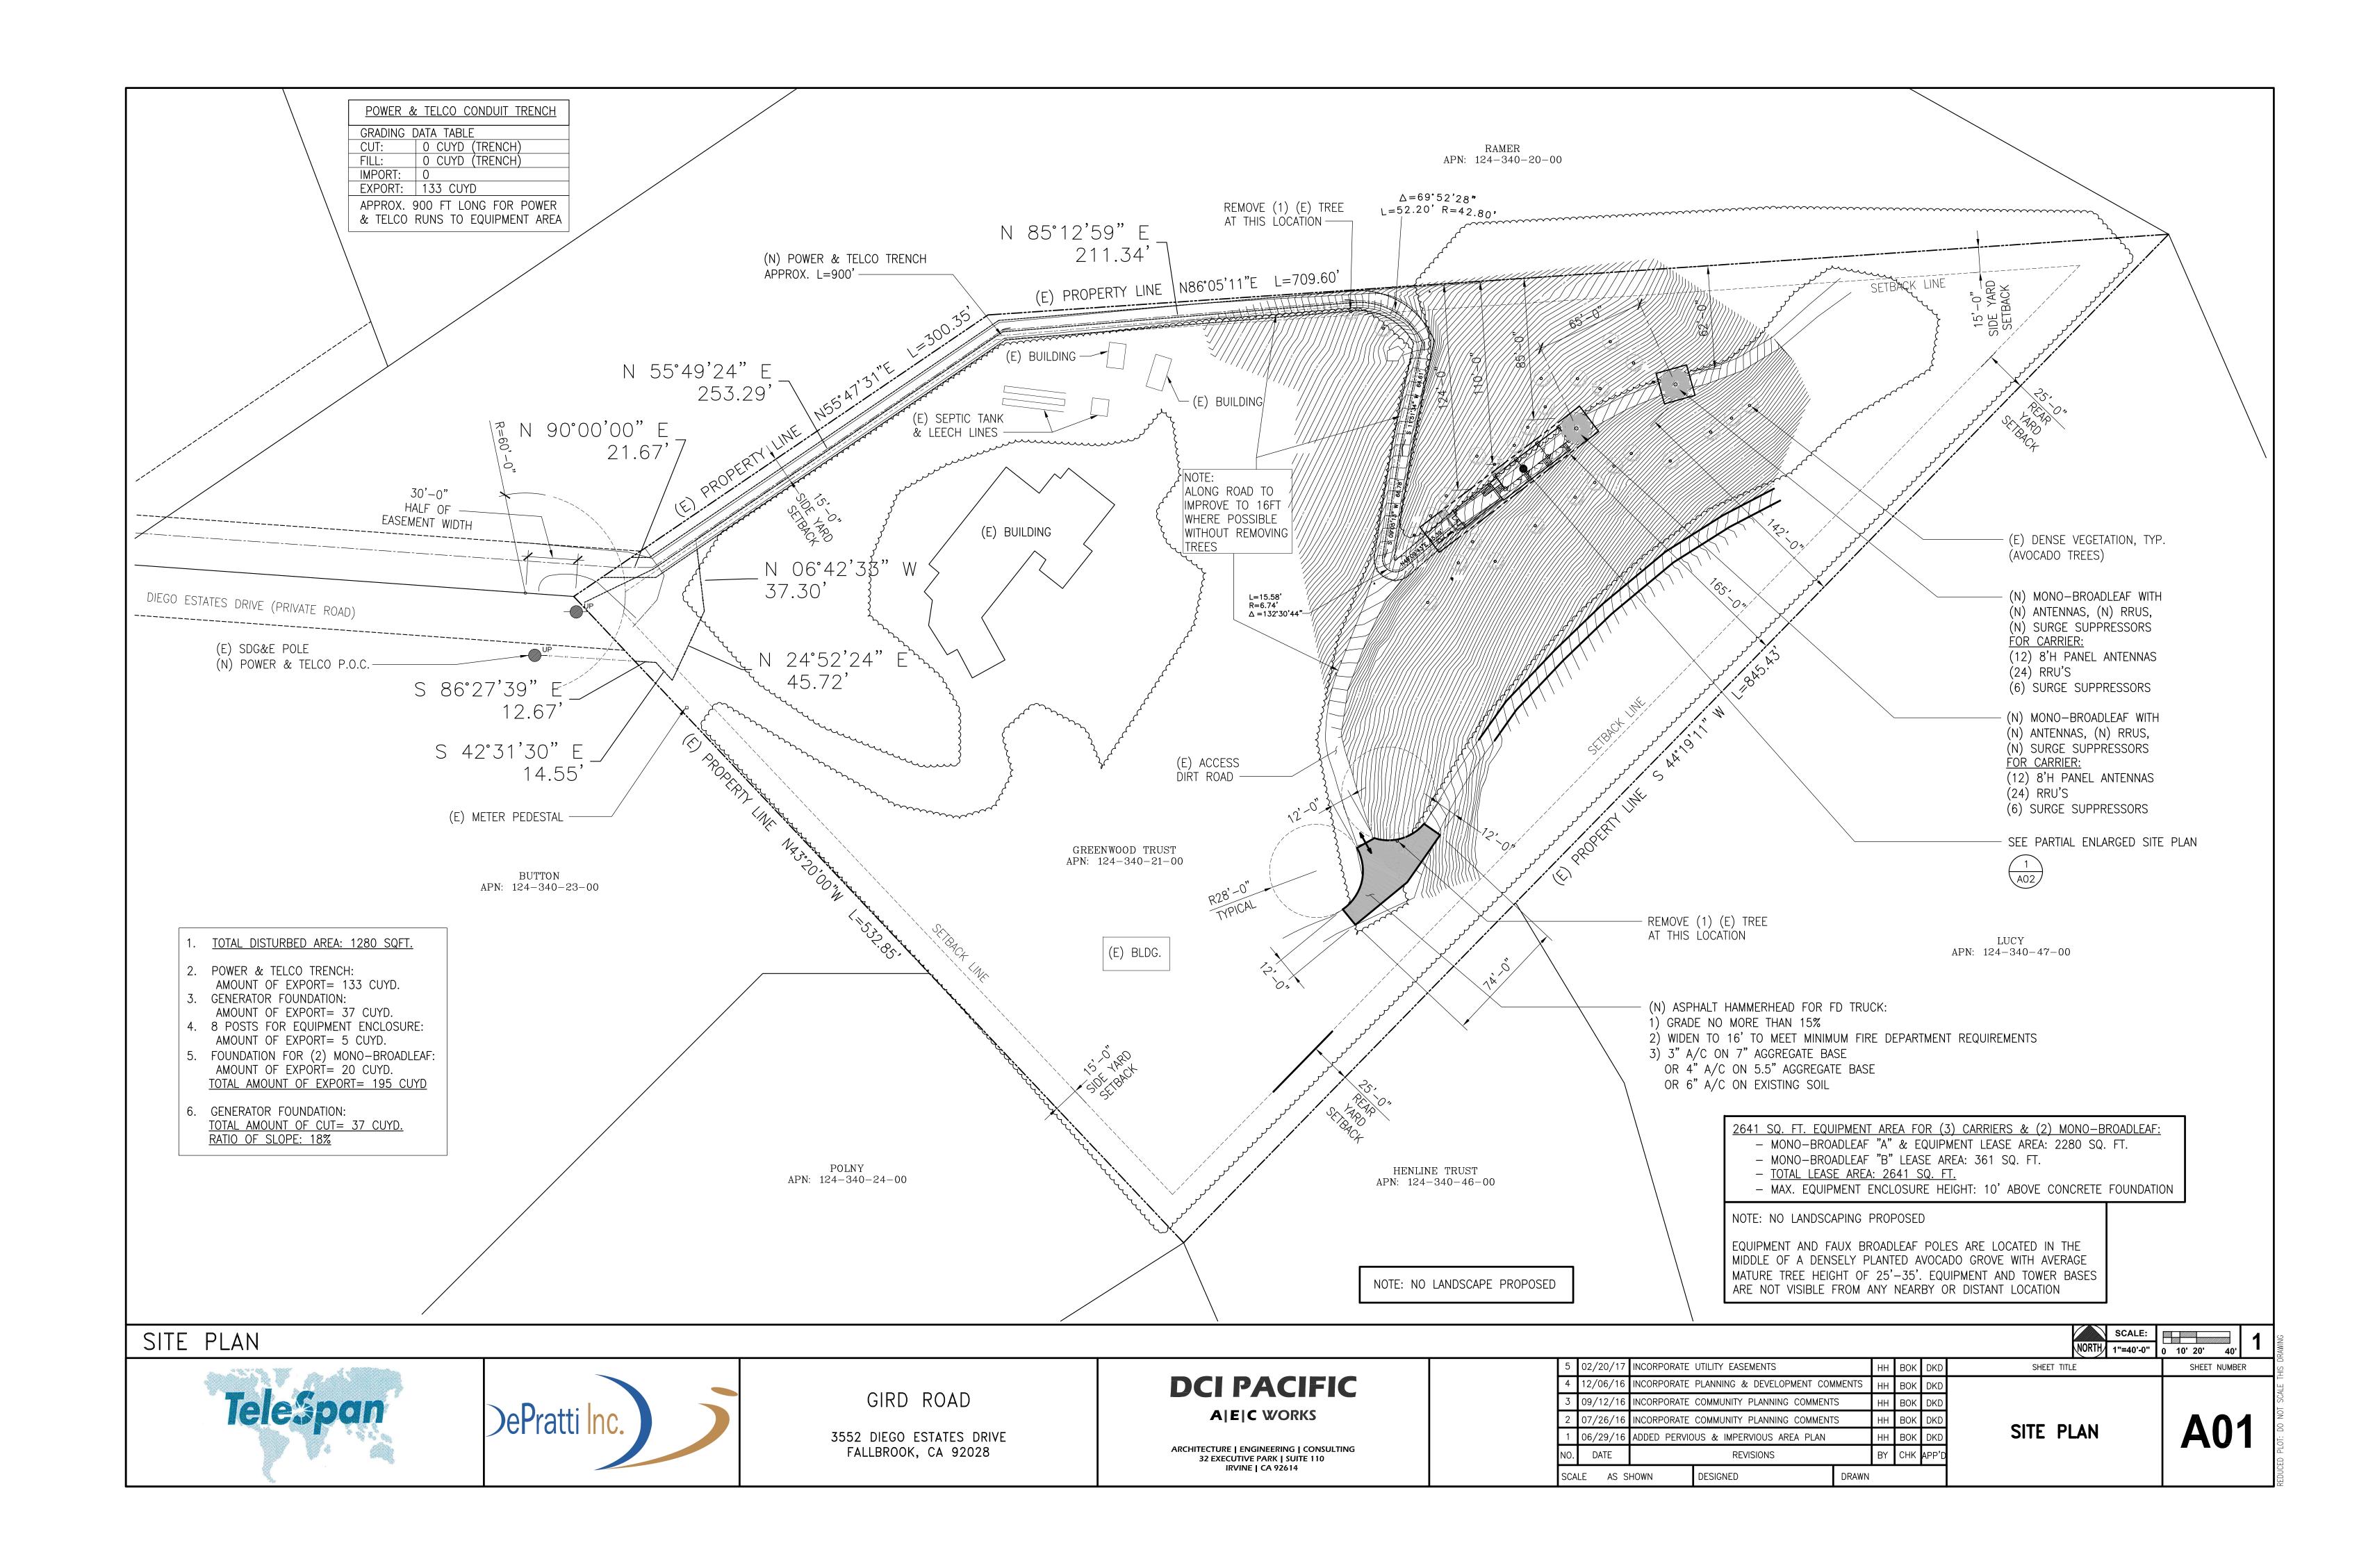

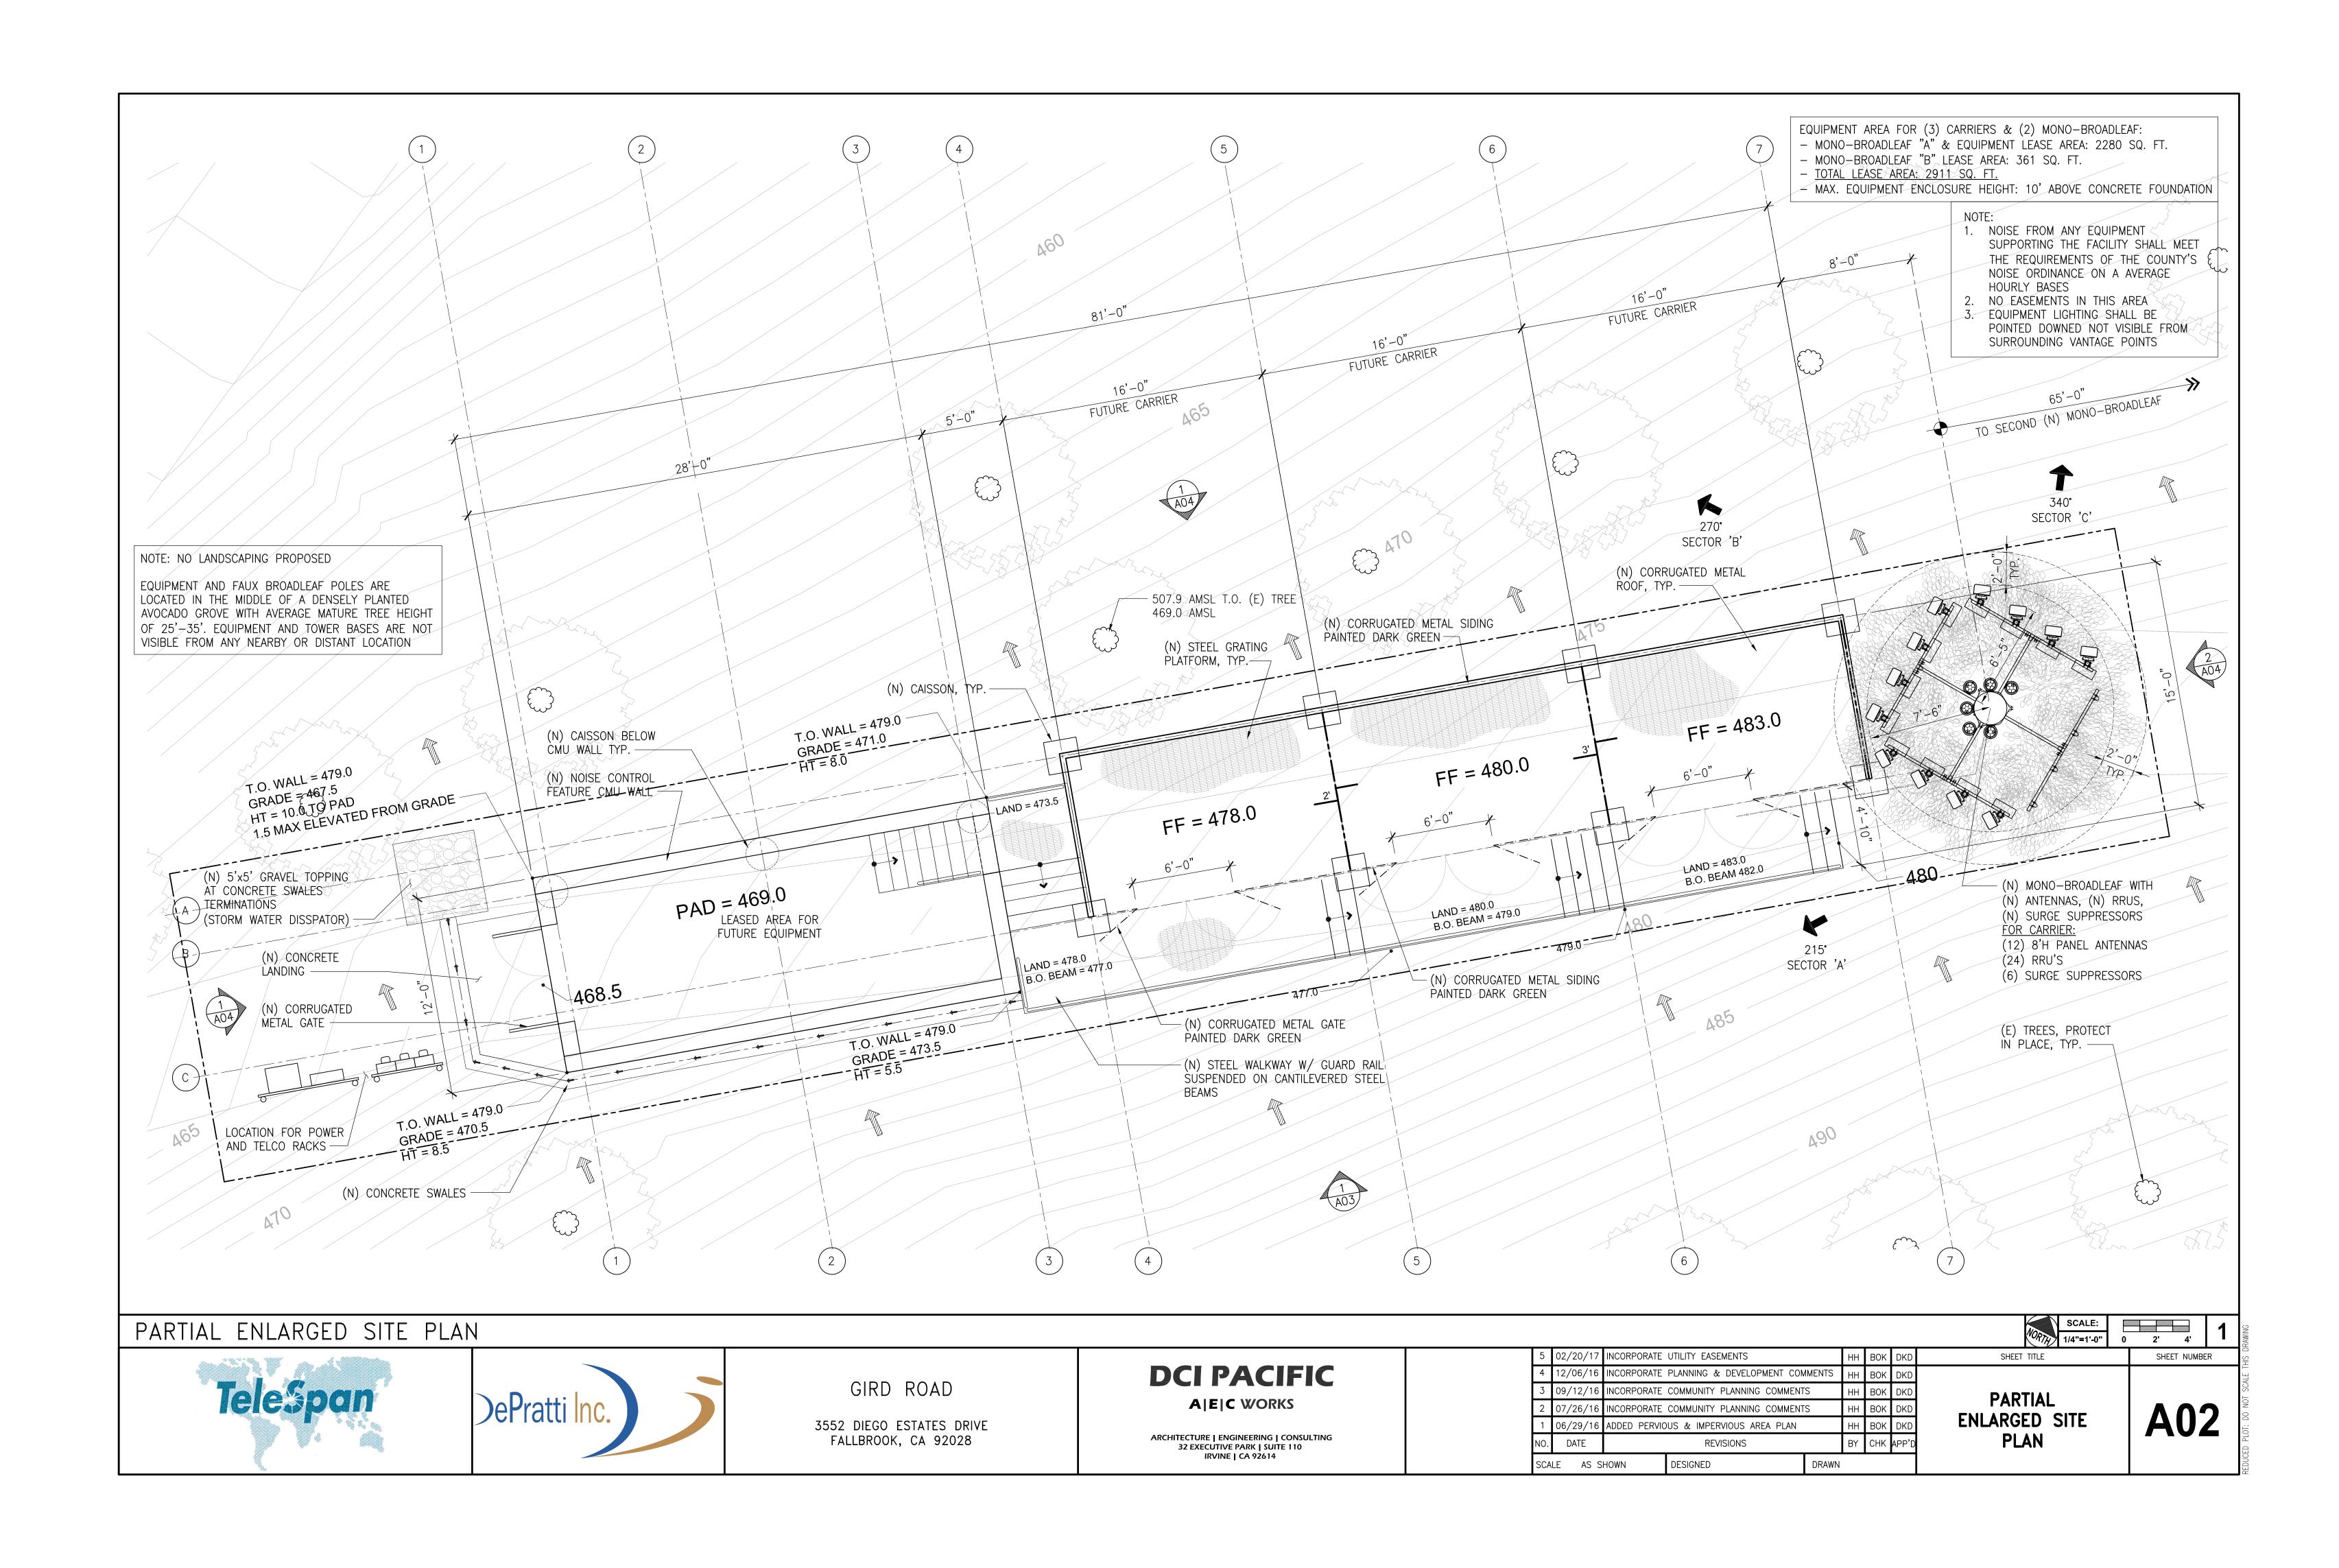

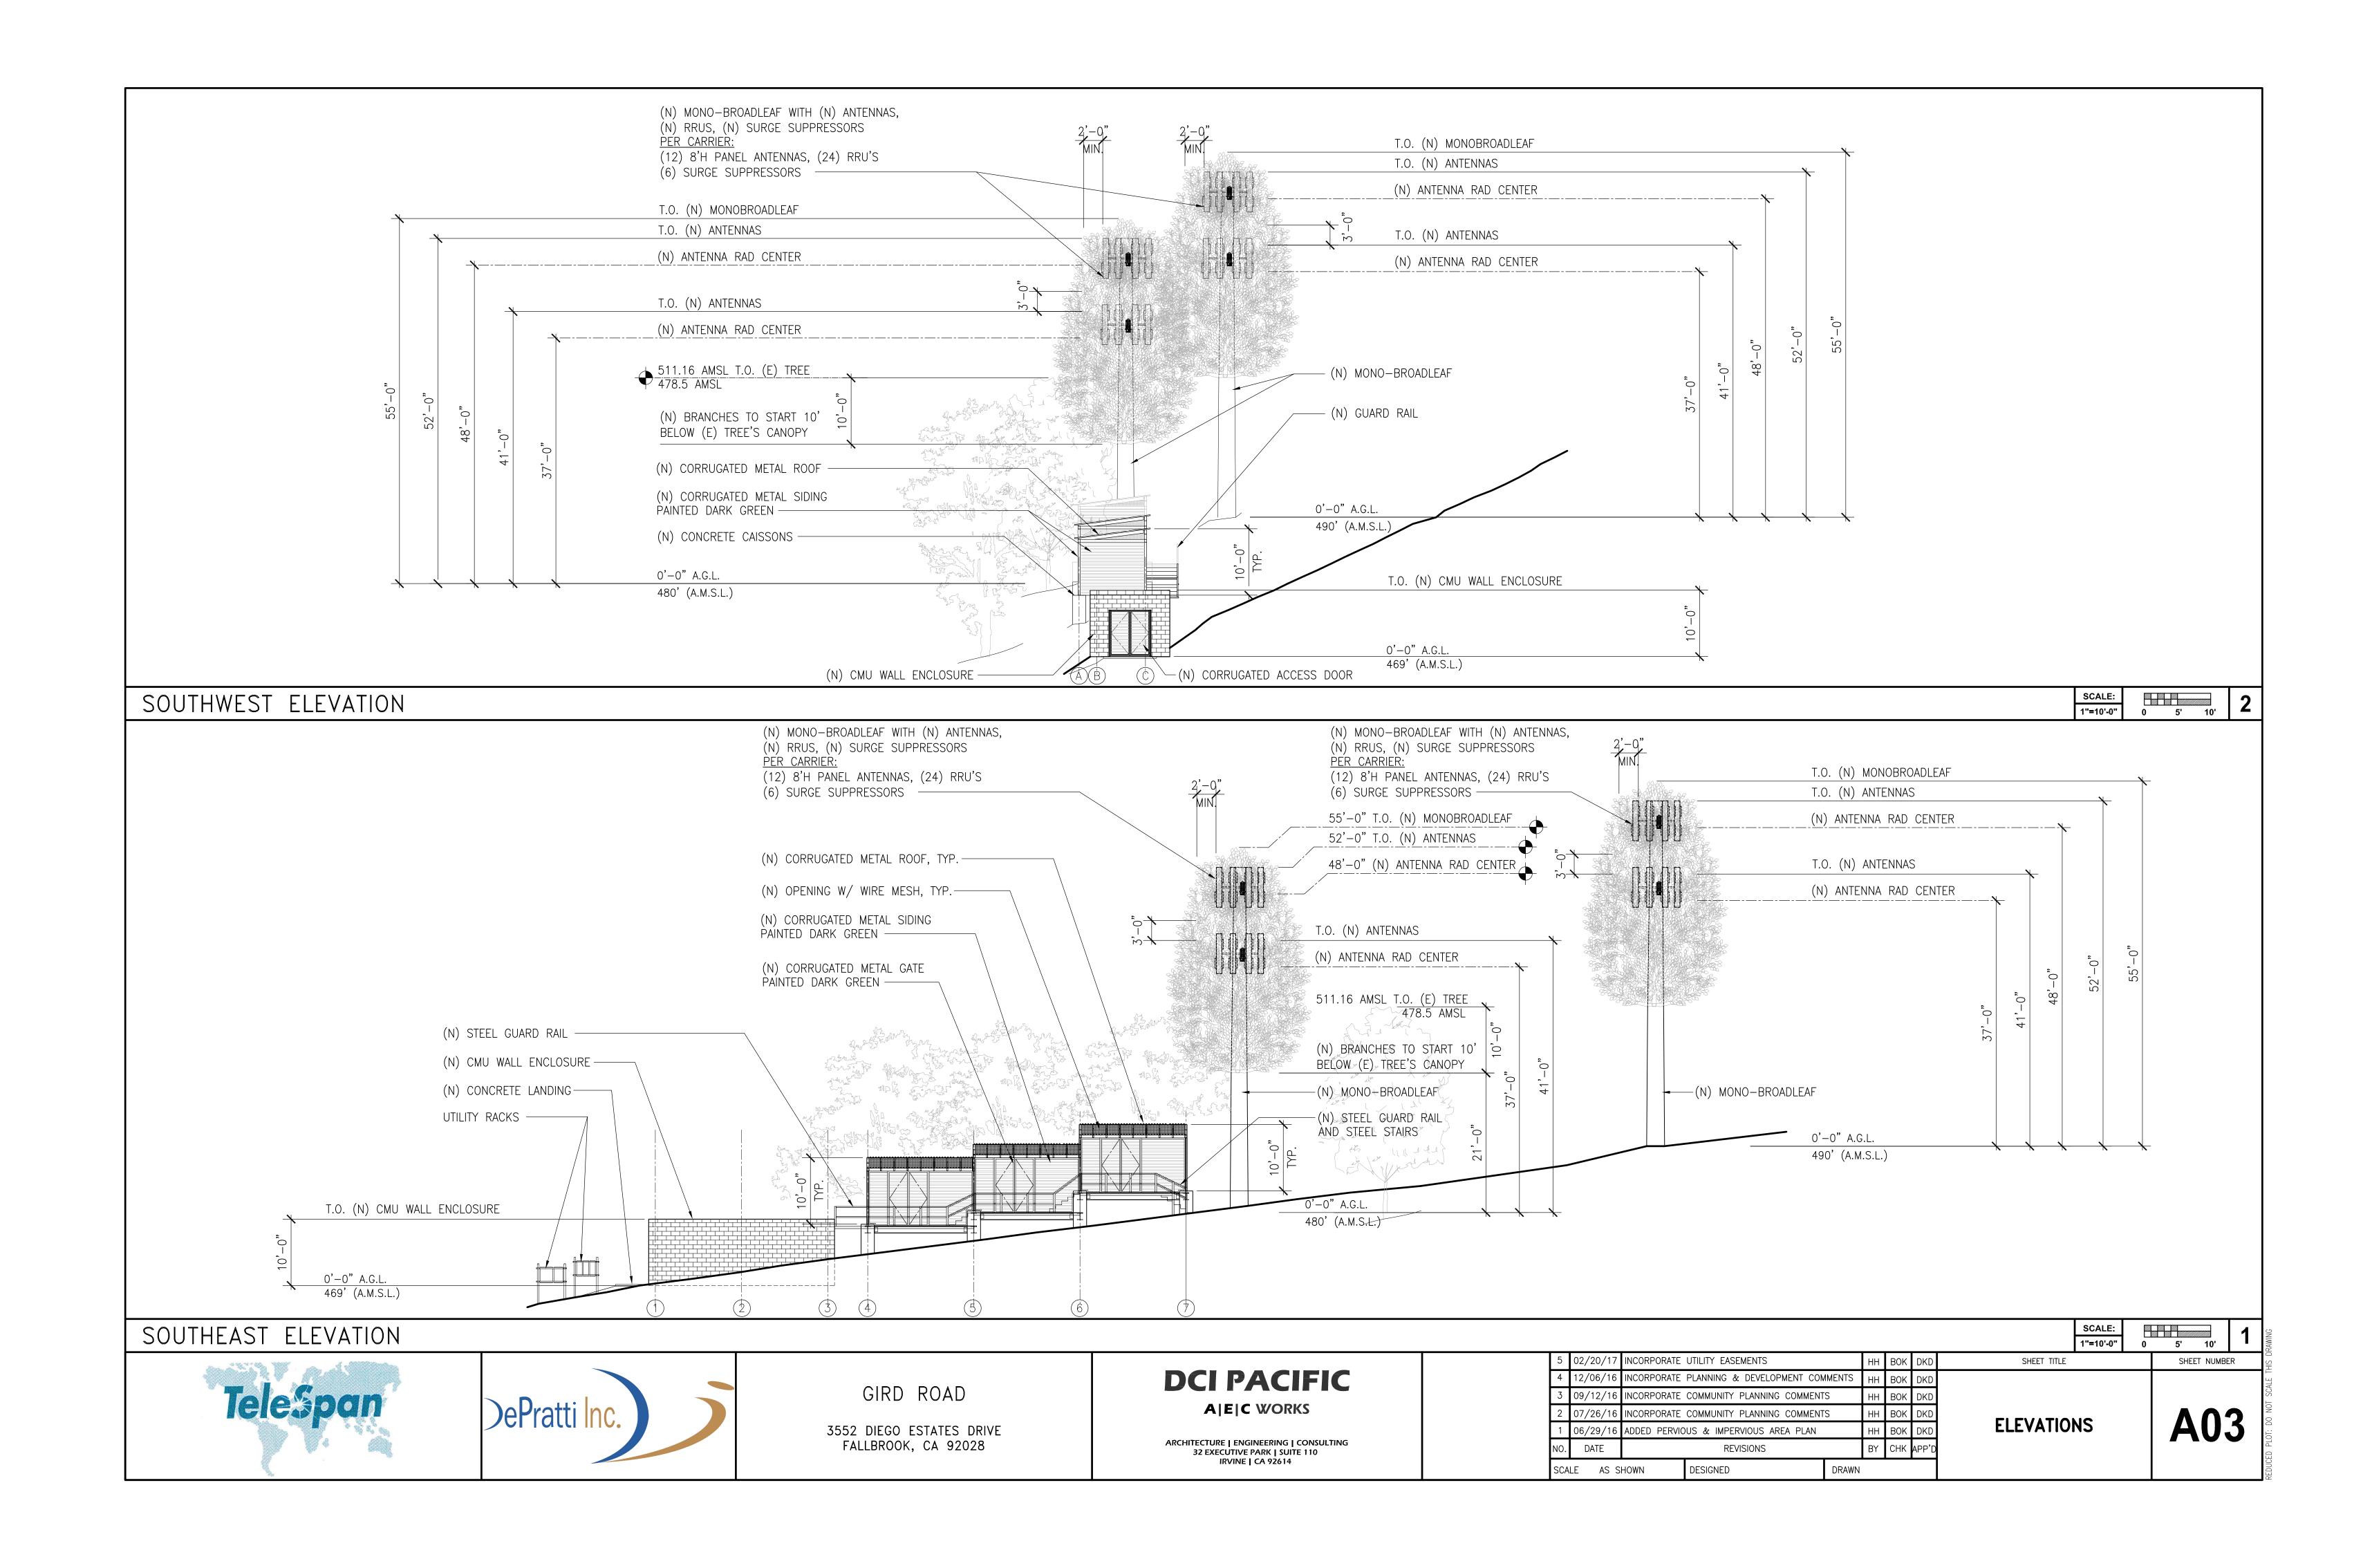

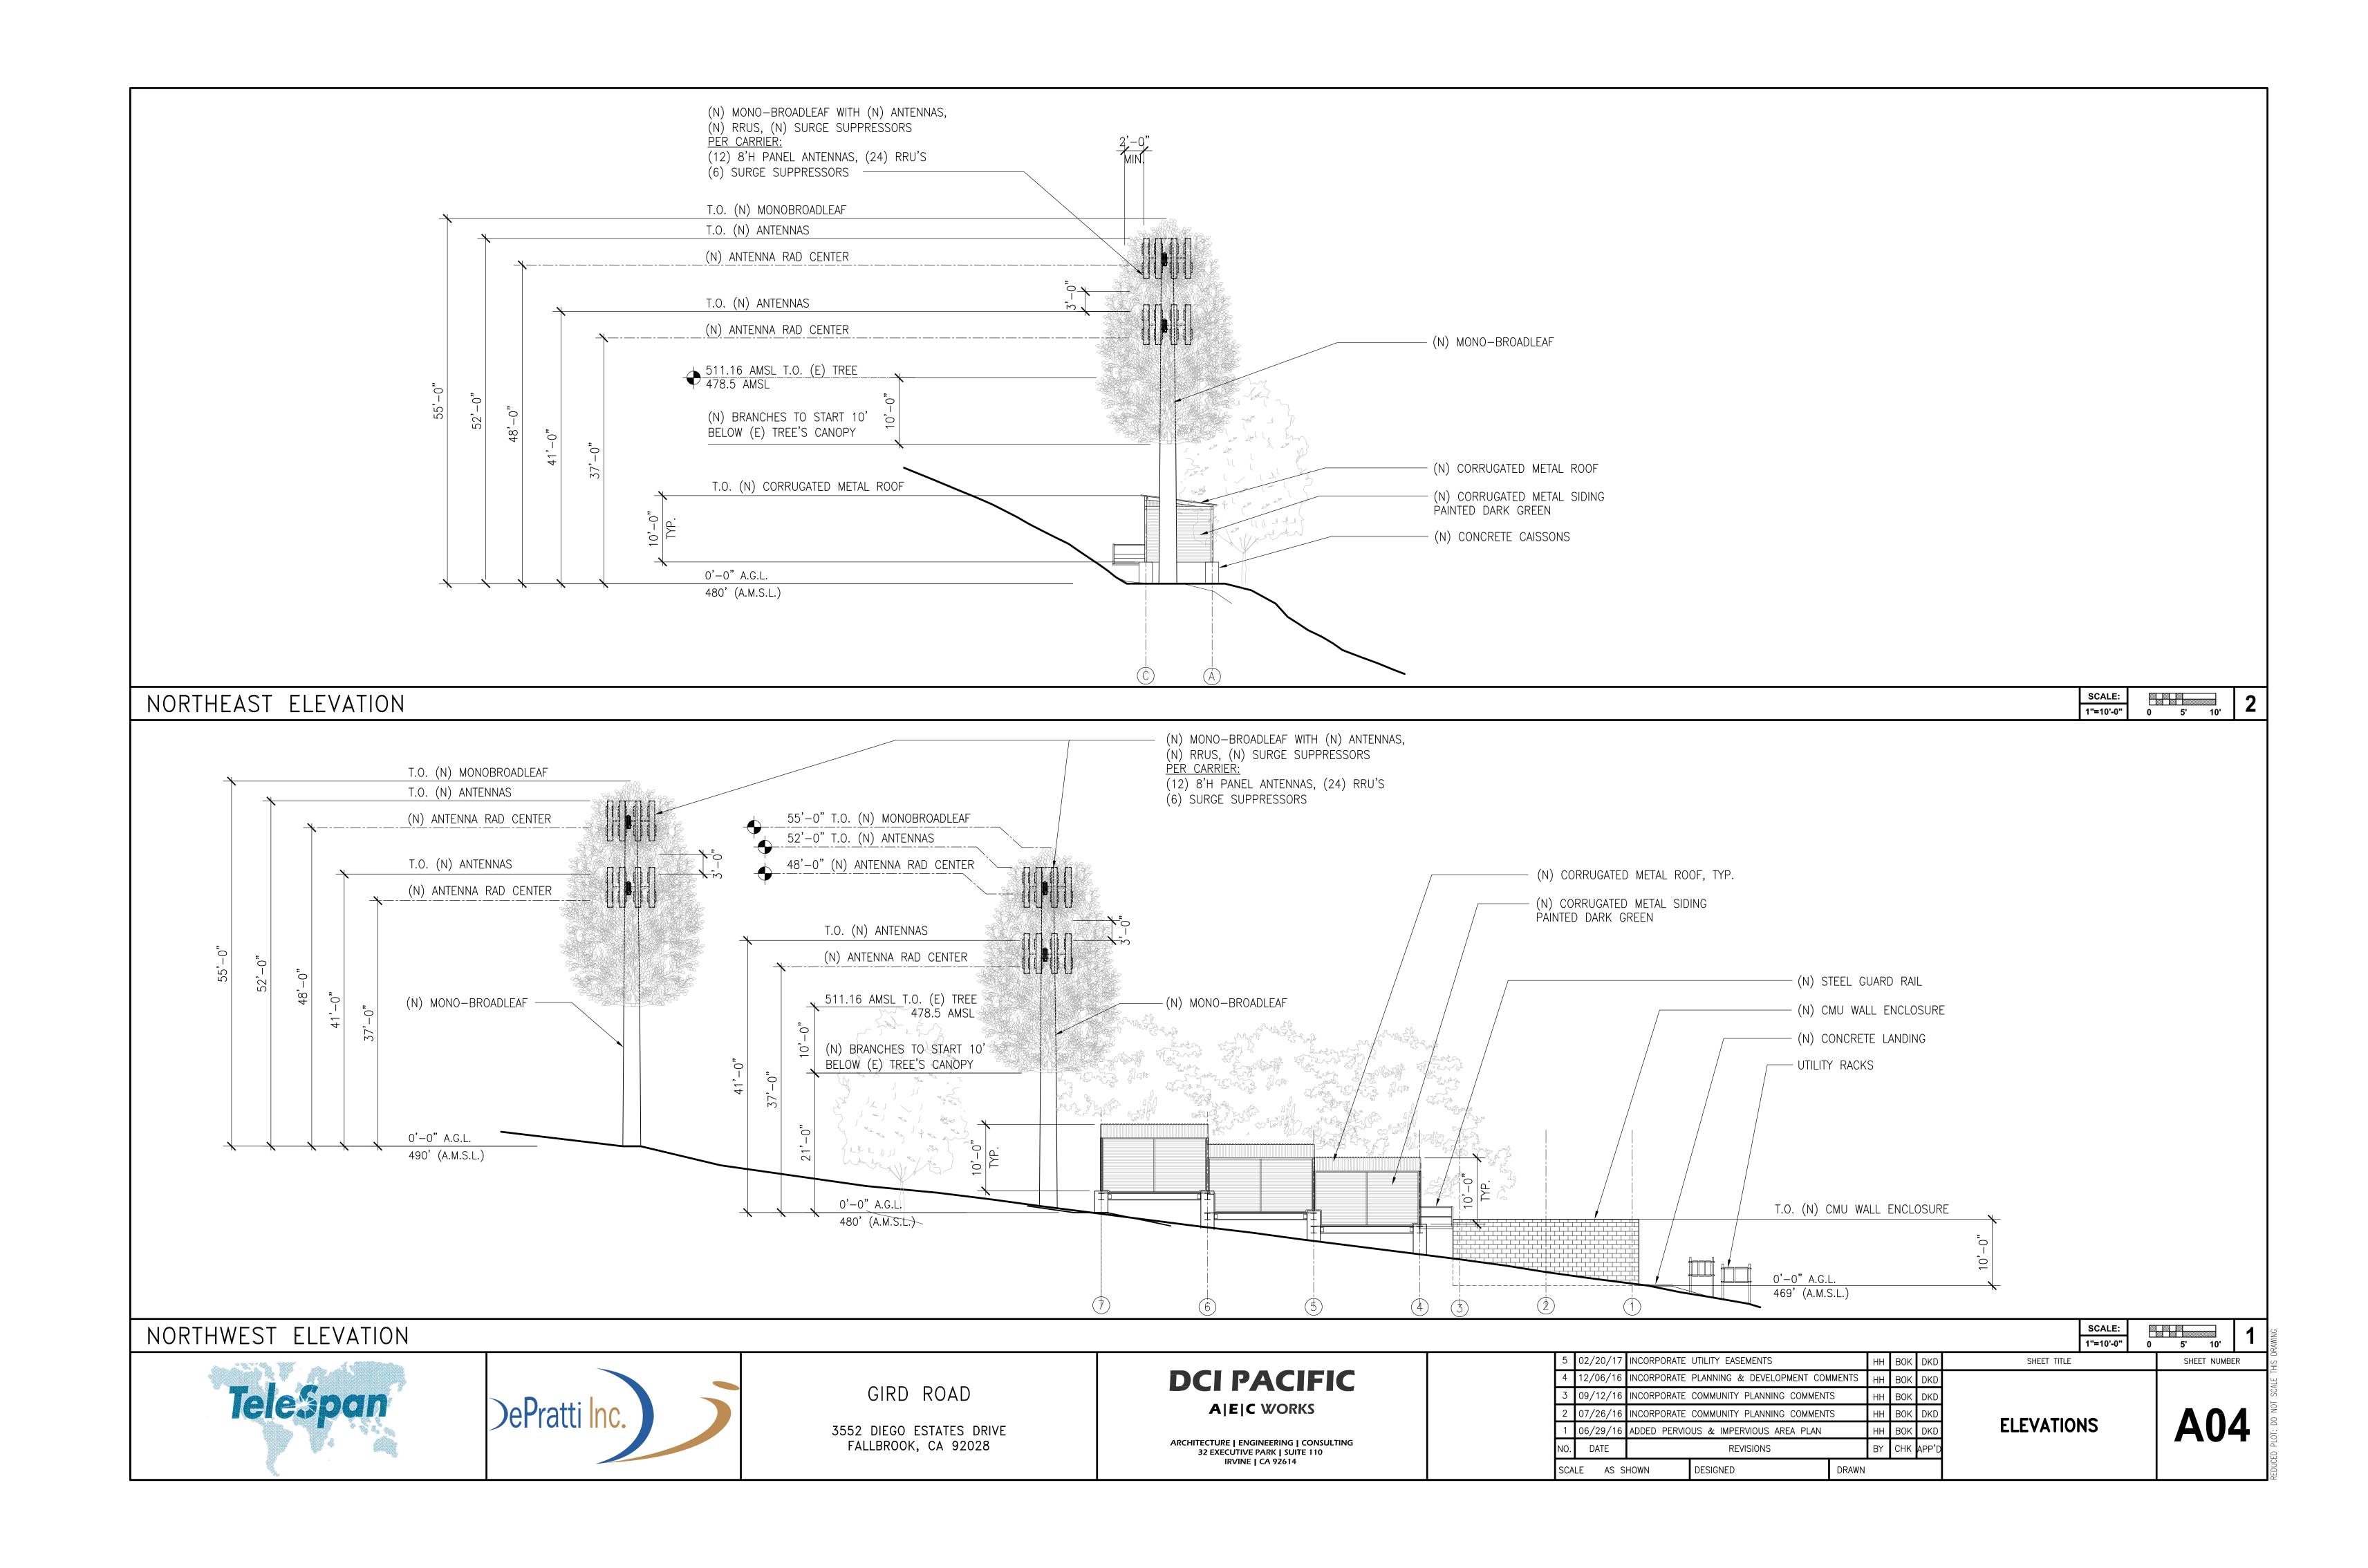

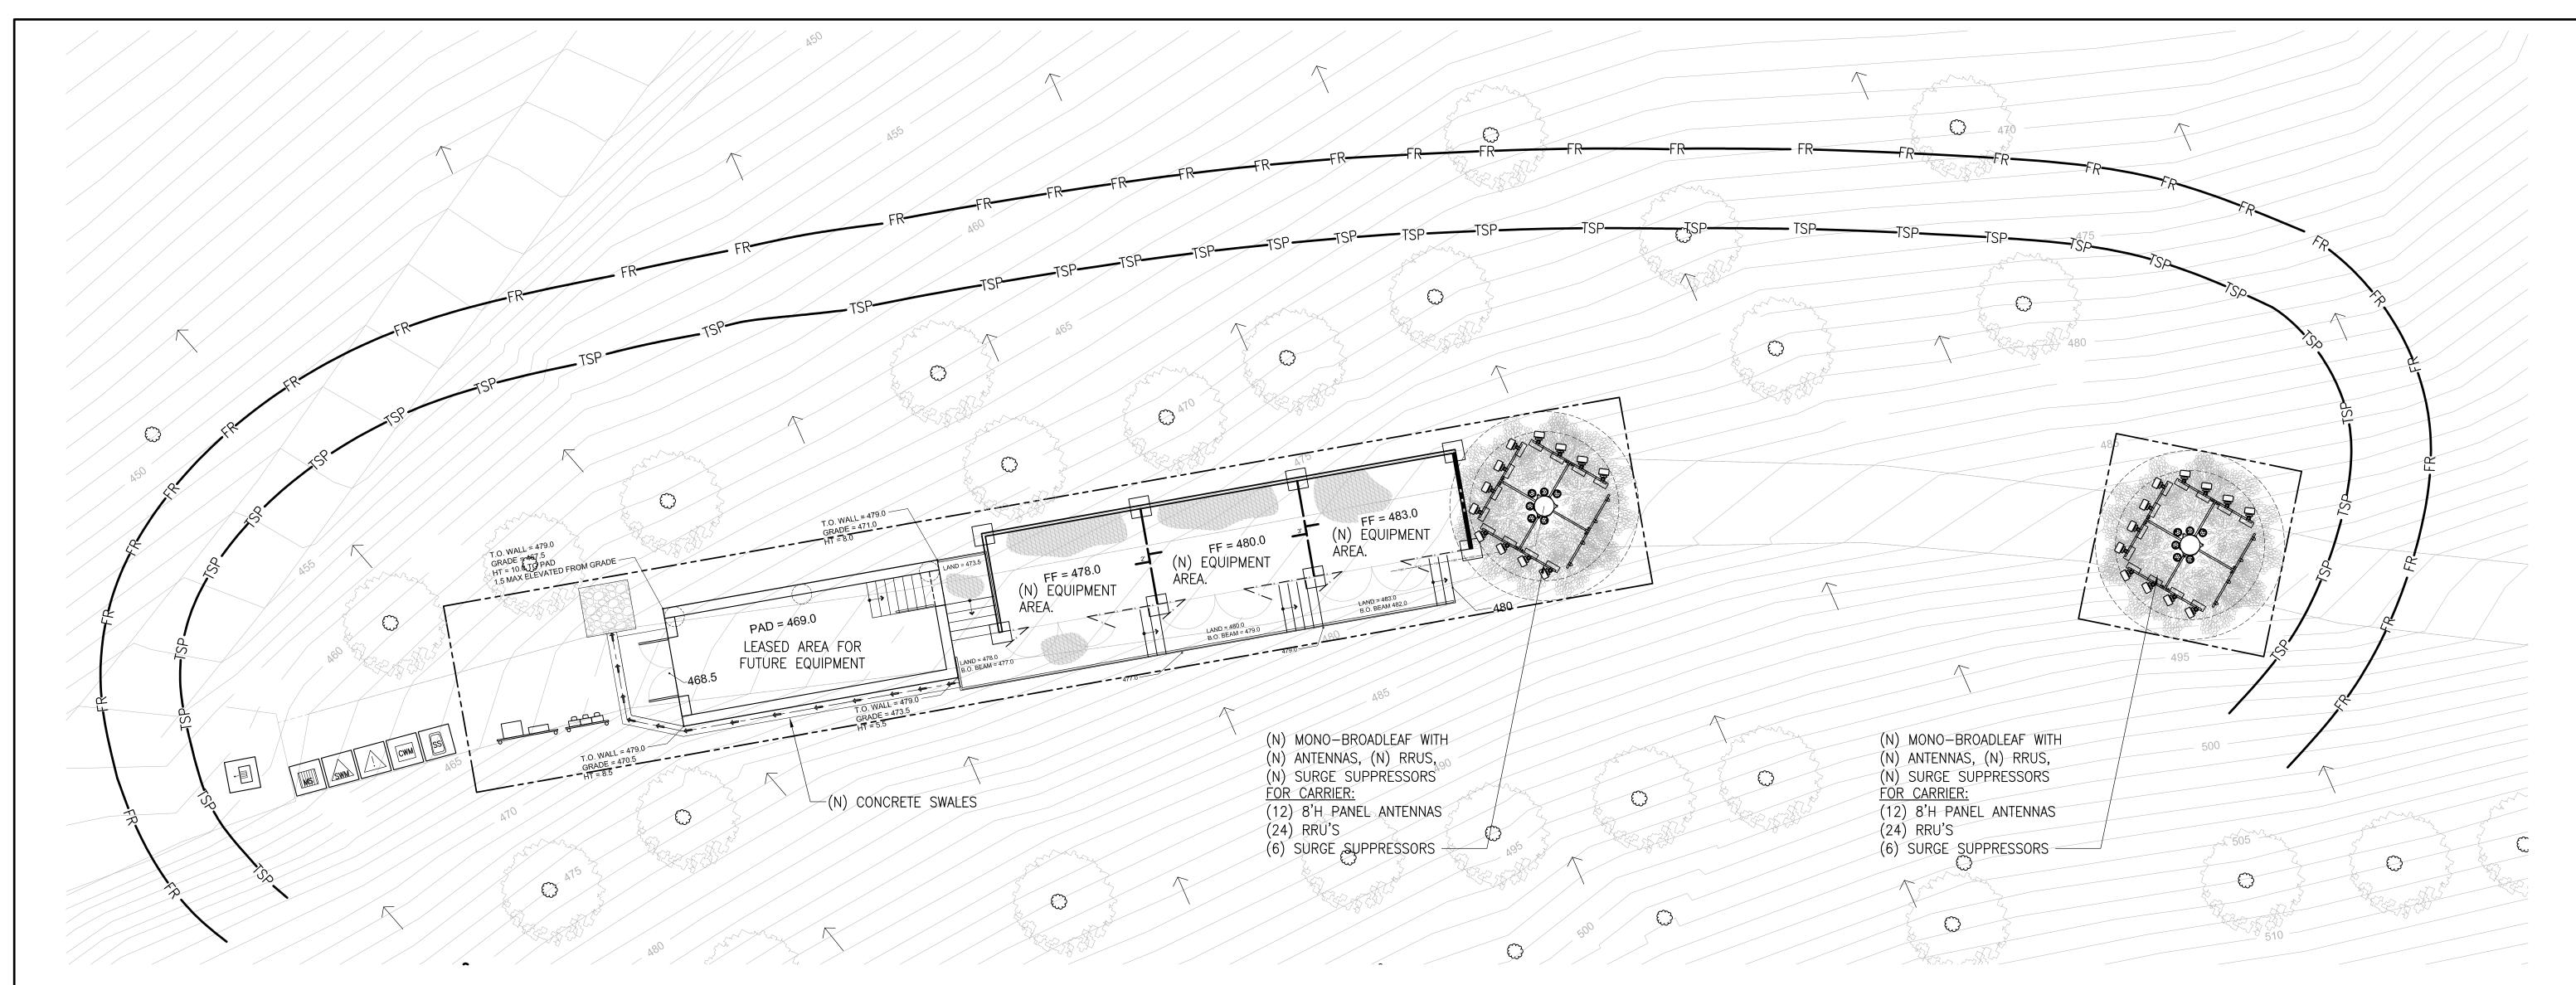

STORM WATER QUALITY NOTES

INVESTIGATIONS & ENFORCEMENT

THE PROGRAM CONDUCTS INVESTIGATIONS OF ILLEGAL POLLUTANT DISCHARGES BY RESIDENTS, BUSINESSES AND PUBLIC AGENCIES INTO THE CITY'S STORM WATER CONVEYANCE SYSTEM. THIS INCLUDES RESPONDING TO REPORTS THAT COME IN VIA: THE STORM WATER POLLUTION HOTLINE, THE REGIONAL REPORTING HOTLINE, AND FROM ACTIVITIES OBSERVED BY STAFF WHILE PATROLLING THEIR ASSIGNED AREA. THE PROGRAM ALSO PREPARES CASES FOR CIVIL PENALTY HEARINGS BEFORE AN ADMINISTRATIVE LAW JUDGE.

PUBLIC EDUCATION & TRAINING SECTION

THE PROGRAM CREATES AND CONDUCTS STORM WATER POLLUTION PREVENTION PUBLIC EDUCATION AND OUTREACH TO MORE THAN 1.2 MILLION RESIDENTS, 70,000 BUSINESSES, AND GOVERNMENT AGENCIES OPERATING IN THE CITY LIMITS. THE PROGRAM ALSO EDUCATES AND TRAINS CITY STAFF ON THE CITY'S STORM DRAIN COLLECTION SYSTEM, THE POLLUTANTS THAT CAUSE BEACH CLOSURES AND THE BEHAVIORS THEY CAN ADOPT AT WORK AND AT HOME TO IMPROVE THE WATER QUALITY OF SAN DIEGO'S BEACHES, BAYS AND WATERSHEDS.

WATERSHED COORDINATION

THE PROGRAM WORKS TO IMPROVE SAN DIEGO'S WATERSHEDS AND ECO-SYSTEMS, BY CHANGING THE WAY DEVELOPMENT IS CONCEIVED, DESIGNED AND PERMITTED IN THE CITY OF SAN DIEGO. THE PROGRAM LEADS A CITYWIDE EFFORT TO RETOOL AND RECONFIGURE EXISTING POLICIES, PROCEDURES AND DEVELOPMENT PERMITS TO INCORPORATE PRO-ACTIVE STORM WATER POLLUTION PREVENTION STRATEGIES.

RECEIVING WATER MONITORING

THE PROGRAM SAMPLES, MONITORS AND RECORDS THE HEALTH OF RECREATIONAL WATERS THROUGHOUT THE CITY OF SAN DIEGO. THE DATA ACCUMULATED WILL ASSIST THE CITY IN SETTING PRIORITIES, DETERMINING APPROPRIATE REMEDIES AND IDENTIFYING EDUCATION.

ENGINEERING BEST MANAGEMENT PRACTICES DEVELOPMENT

THE PROGRAM DEVELOPS CITYWIDE STANDARDS FOR ON-SITE STORM WATER POLLUTION PREVENTION PRACTICES AND ACTIVITIES AT PUBLIC AND PRIVATE CONSTRUCTION SITES. IT ALSO WORKS WITH THE CONSTRUCTION AND DEVELOPMENT INDUSTRY TO SHARE INFORMATION ON "BEST MANAGEMENT PRACTICES" AND ENGINEERING DESIGN STRATEGIES THAT WILL REDUCE AND PREVENT SEDIMENT, EROSION AND OTHER CONSTRUCTION DISCHARGES FROM ENTERING THE CITY'S STORM DRAIN COLLECTION SYSTEM.

ADMINISTRATIVE SUPPORT

THIS SECTION IS RESPONSIBLE FOR TRACKING AND RECORDING PROGRAM ACHIEVEMENTS IN ALL AREAS; OVERSEEING THE FINANCIAL MANAGEMENT FUNCTIONS FOR THE DIVISION; PRODUCING THE ANNUAL REGIONAL WATER QUALITY CONTROL BOARD REPORT; AND PROVIDING CUSTOMER SERVICE BY ANSWERING THE CITY'S STORM WATER HOTLINE (235-1000) FOR DISCHARGES WITHIN THE CITY OF SAN DIEGO AND PROVIDING INFORMATION TO THE PUBLIC ON A VARIETY OF STORM WATER TOPICS.

LEGEND BEST MANAGEMENT PROTECTION

LEGEND BEST MANAGEMENT PROTECTION							
DESCRIPTION	QUANTITY	SYMBOL					
MATERIAL DELIVERY AND STORAGE	WM-1	1 EA					
SOLID WASTE MANAGEMENT	WM-5	1 EA	SWM				
HAZARDOUS WASTE MANAGEMENT	WM-6	1 EA					
CONCRETE WASTE MANAGEMENT	WM-8	1 EA	СММ				
SANITARY/SEPTIC WASTE MANAGEMENT	WM-9	1 EA	SS				
ENTRANCE/OUTLET TIRE WASH	TC-3	1 EA	Ţ				
FIBER ROLLS	SC-5	N/A	FR				
HYDROSEEDING (SUMMER)	SS-4	N/A	TSP				
DIRECTION OF SURFACE FLOW		N/A					

BMP/PLOT PLAN





GIRD ROAD

3552 DIEGO ESTATES DRIVE FALLBROOK, CA 92028

DCI PACIFIC A|E|C WORKS

ARCHITECTURE | ENGINEERING | CONSULTING 32 EXECUTIVE PARK | SUITE 110 IRVINE | CA 92614


SCA	LE AS S	HOWN	DESIGNED	DRAWN			
NO.	DATE	REVISIONS			BY	CHK	APP'D
1	06/29/16	ADDED PERVIOUS & IMPERVIOUS AREA PLAN				BOK	DKD
2	07/26/16	INCORPORATE COMMUNITY PLANNING COMMENTS			НН	BOK	DKD
3	09/12/16	INCORPORATE COMMUNITY PLANNING COMMENTS			HH	BOK	DKD
4	12/06/16	INCORPORATE	PLANNING & DEVELOPMENT COM	MENTS	НН	BOK	DKD
5	02/20/17 INCORPORATE UTILITY EASEMENTS				H	BOK	DKD


BMP/PLOT PLAN


SHEET TITLE


C01


SHEET NUMBER

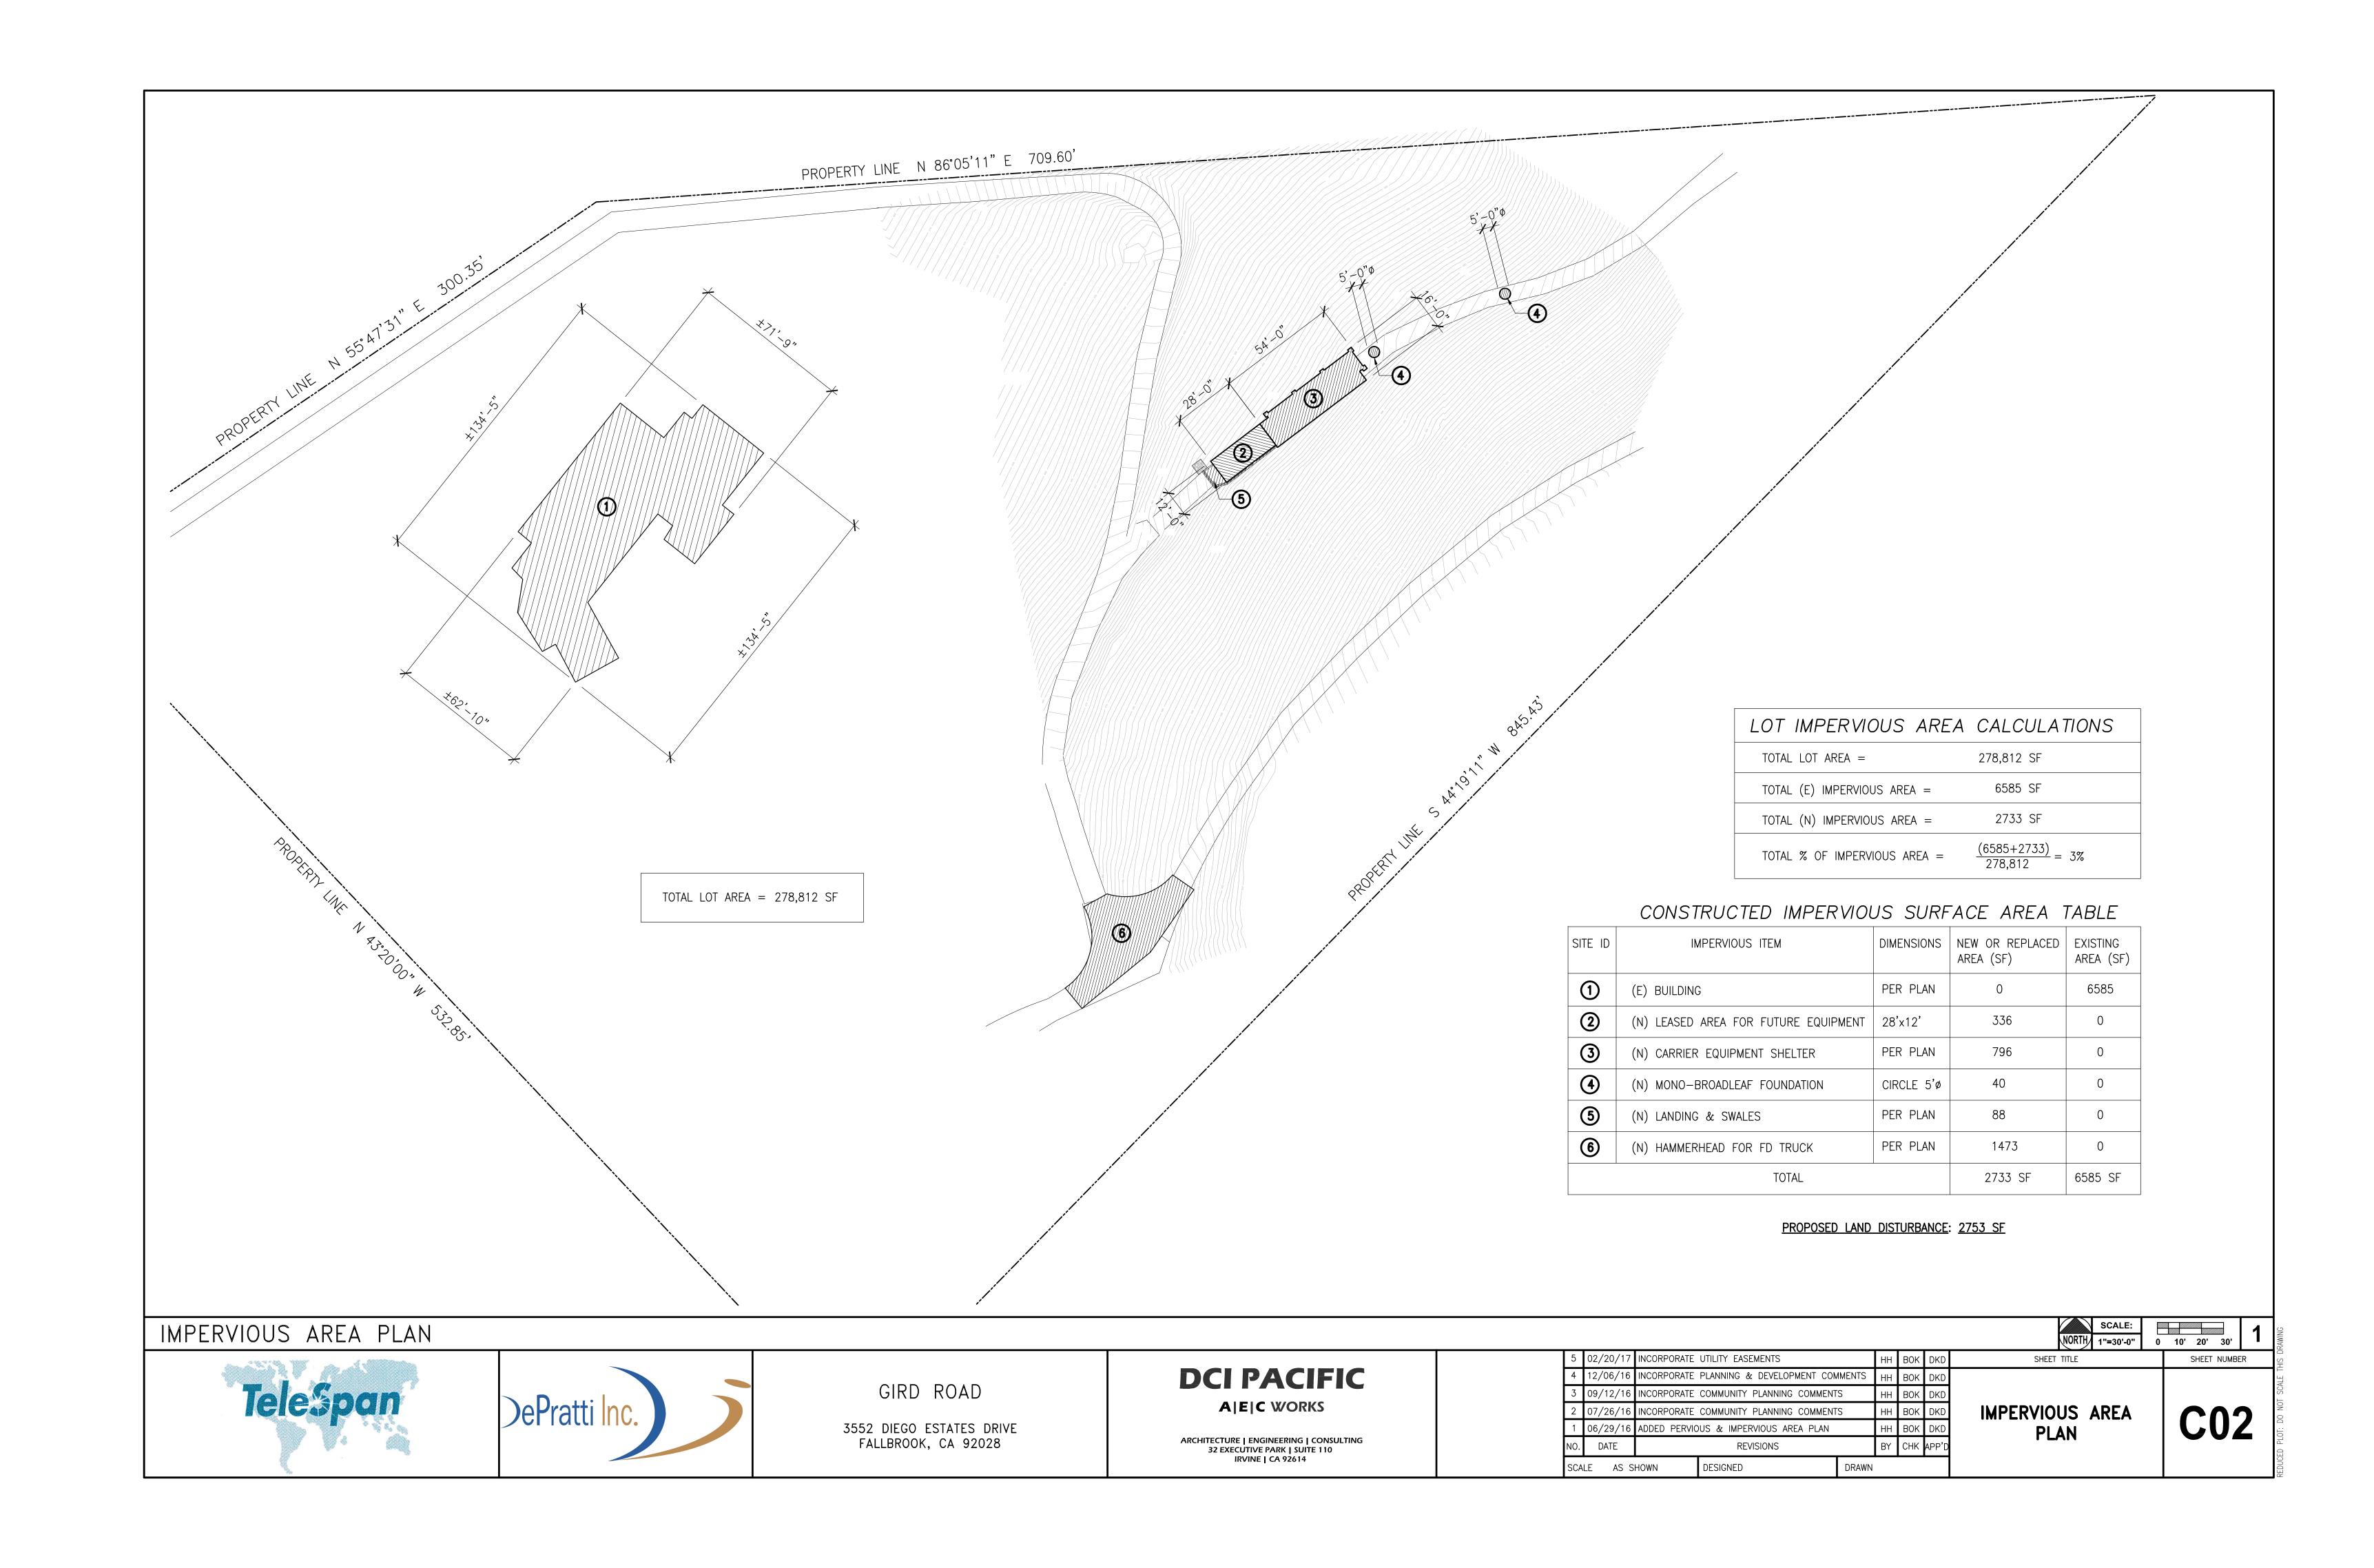

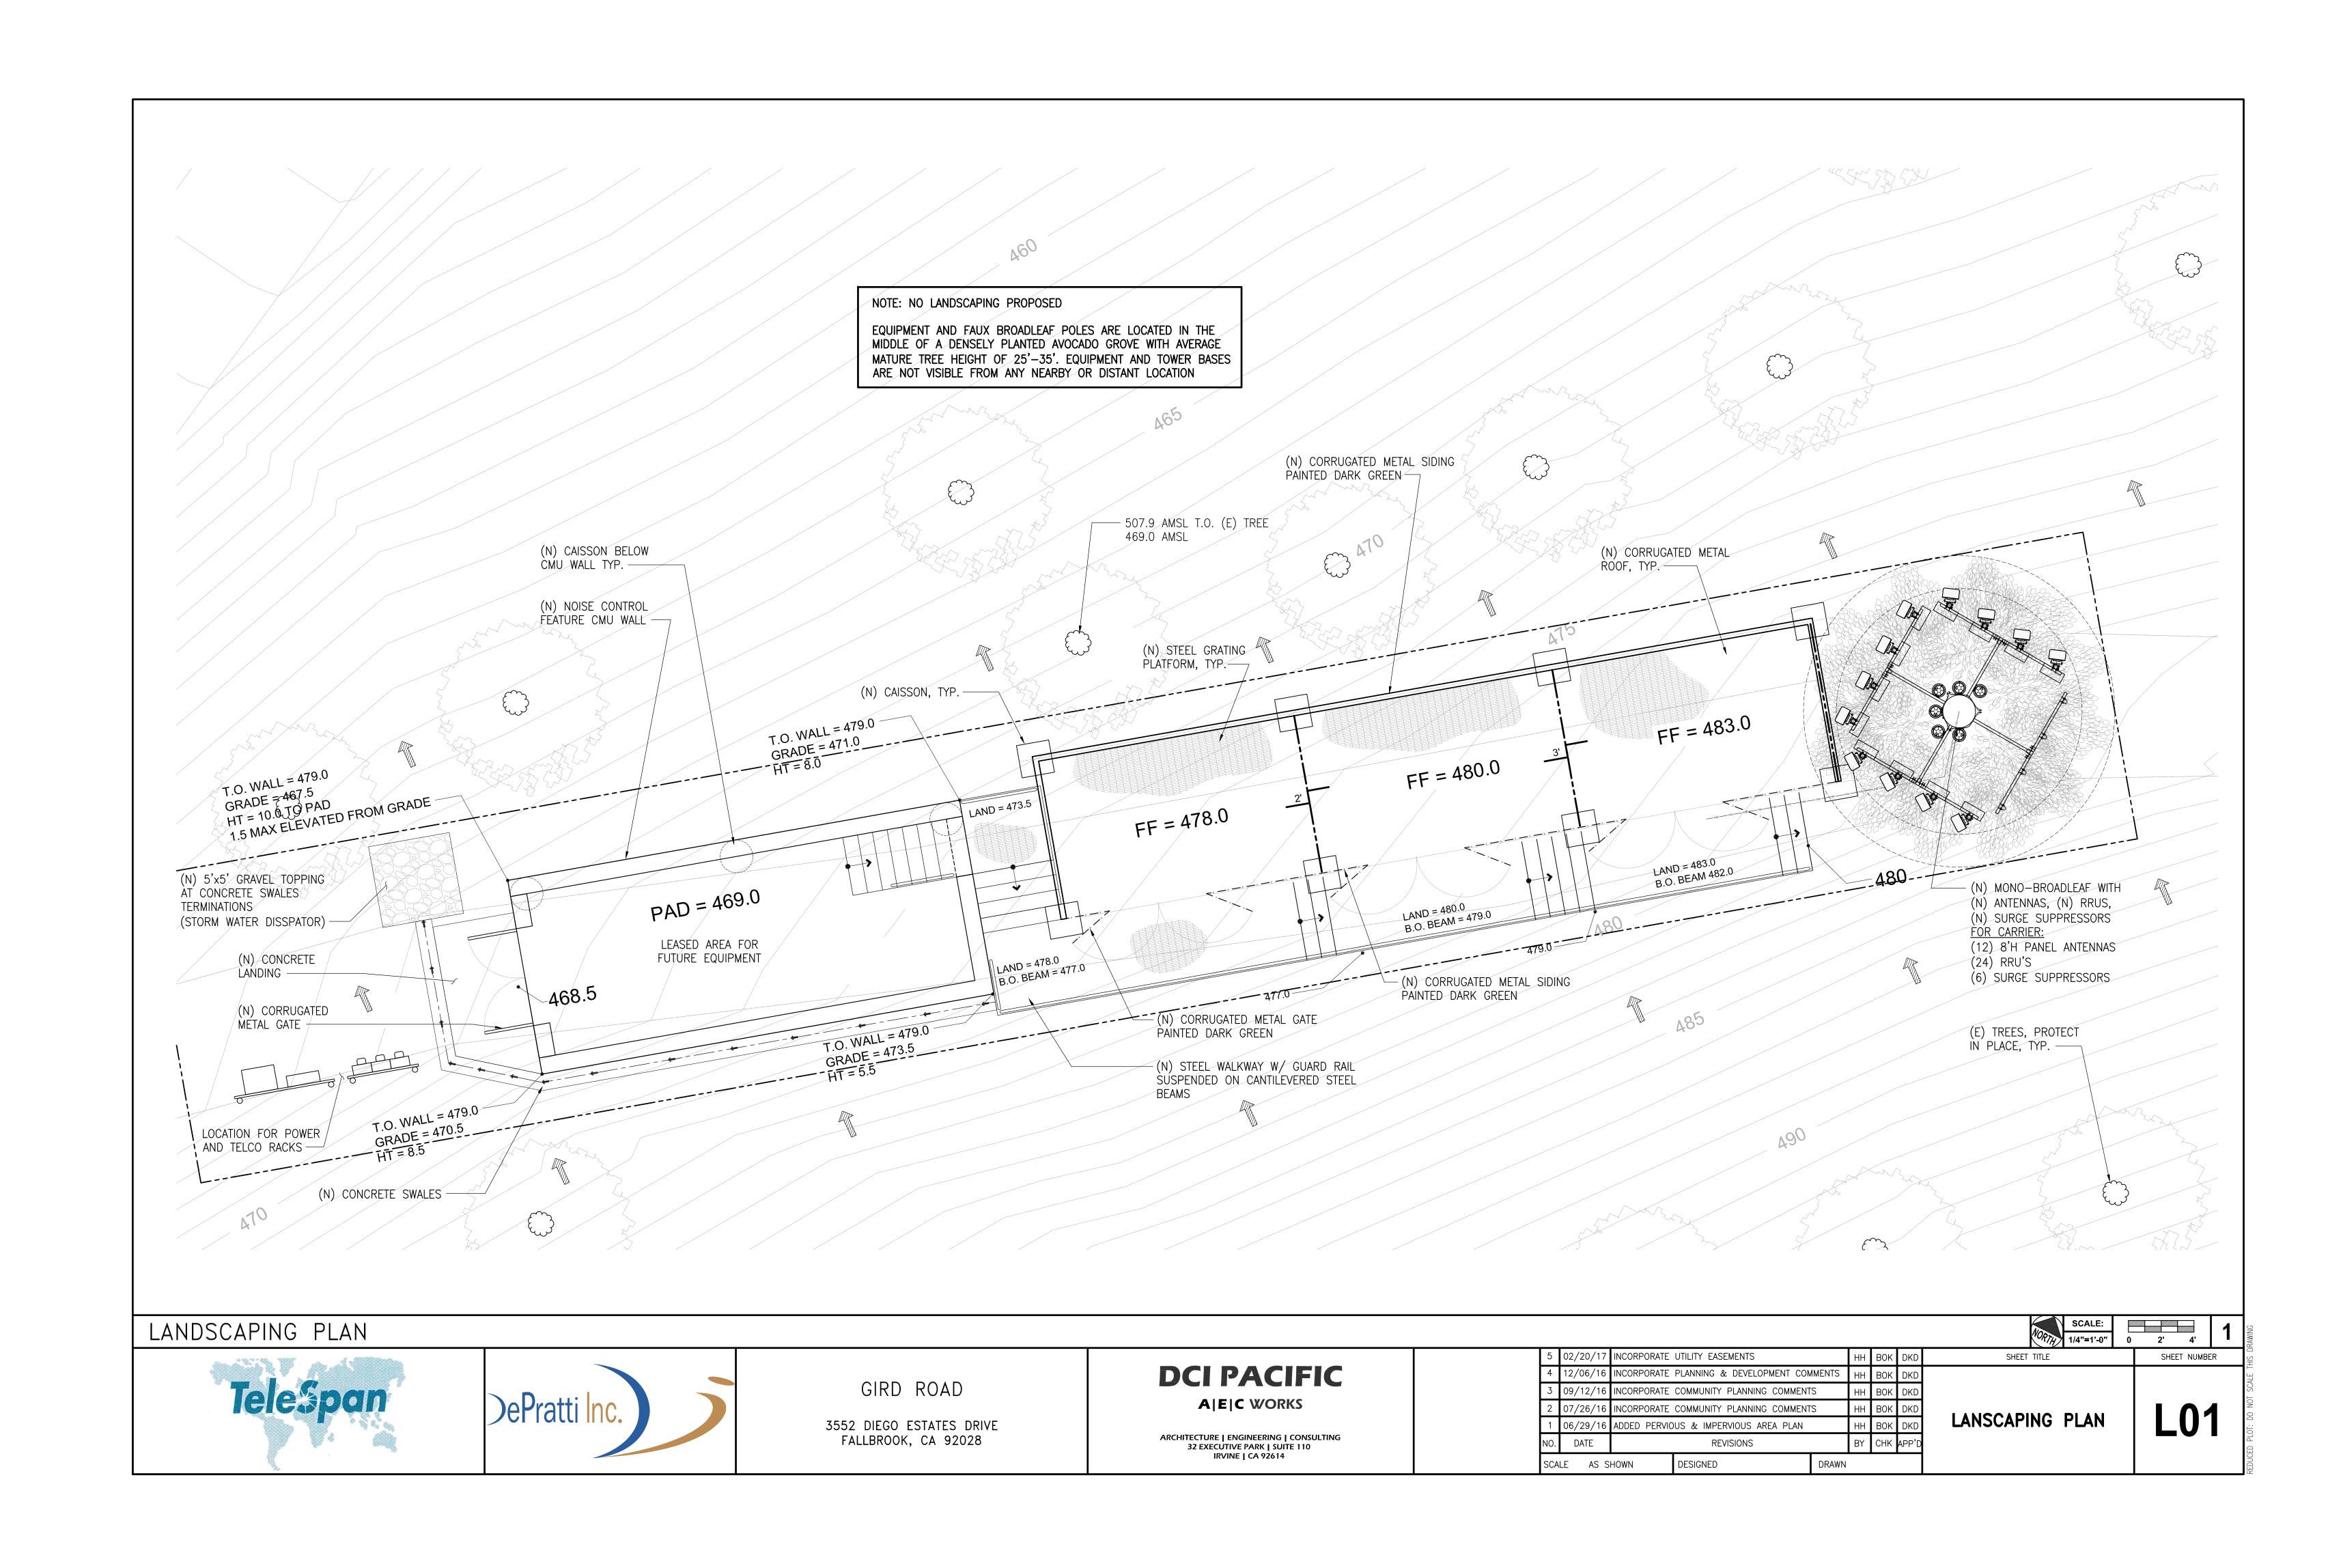

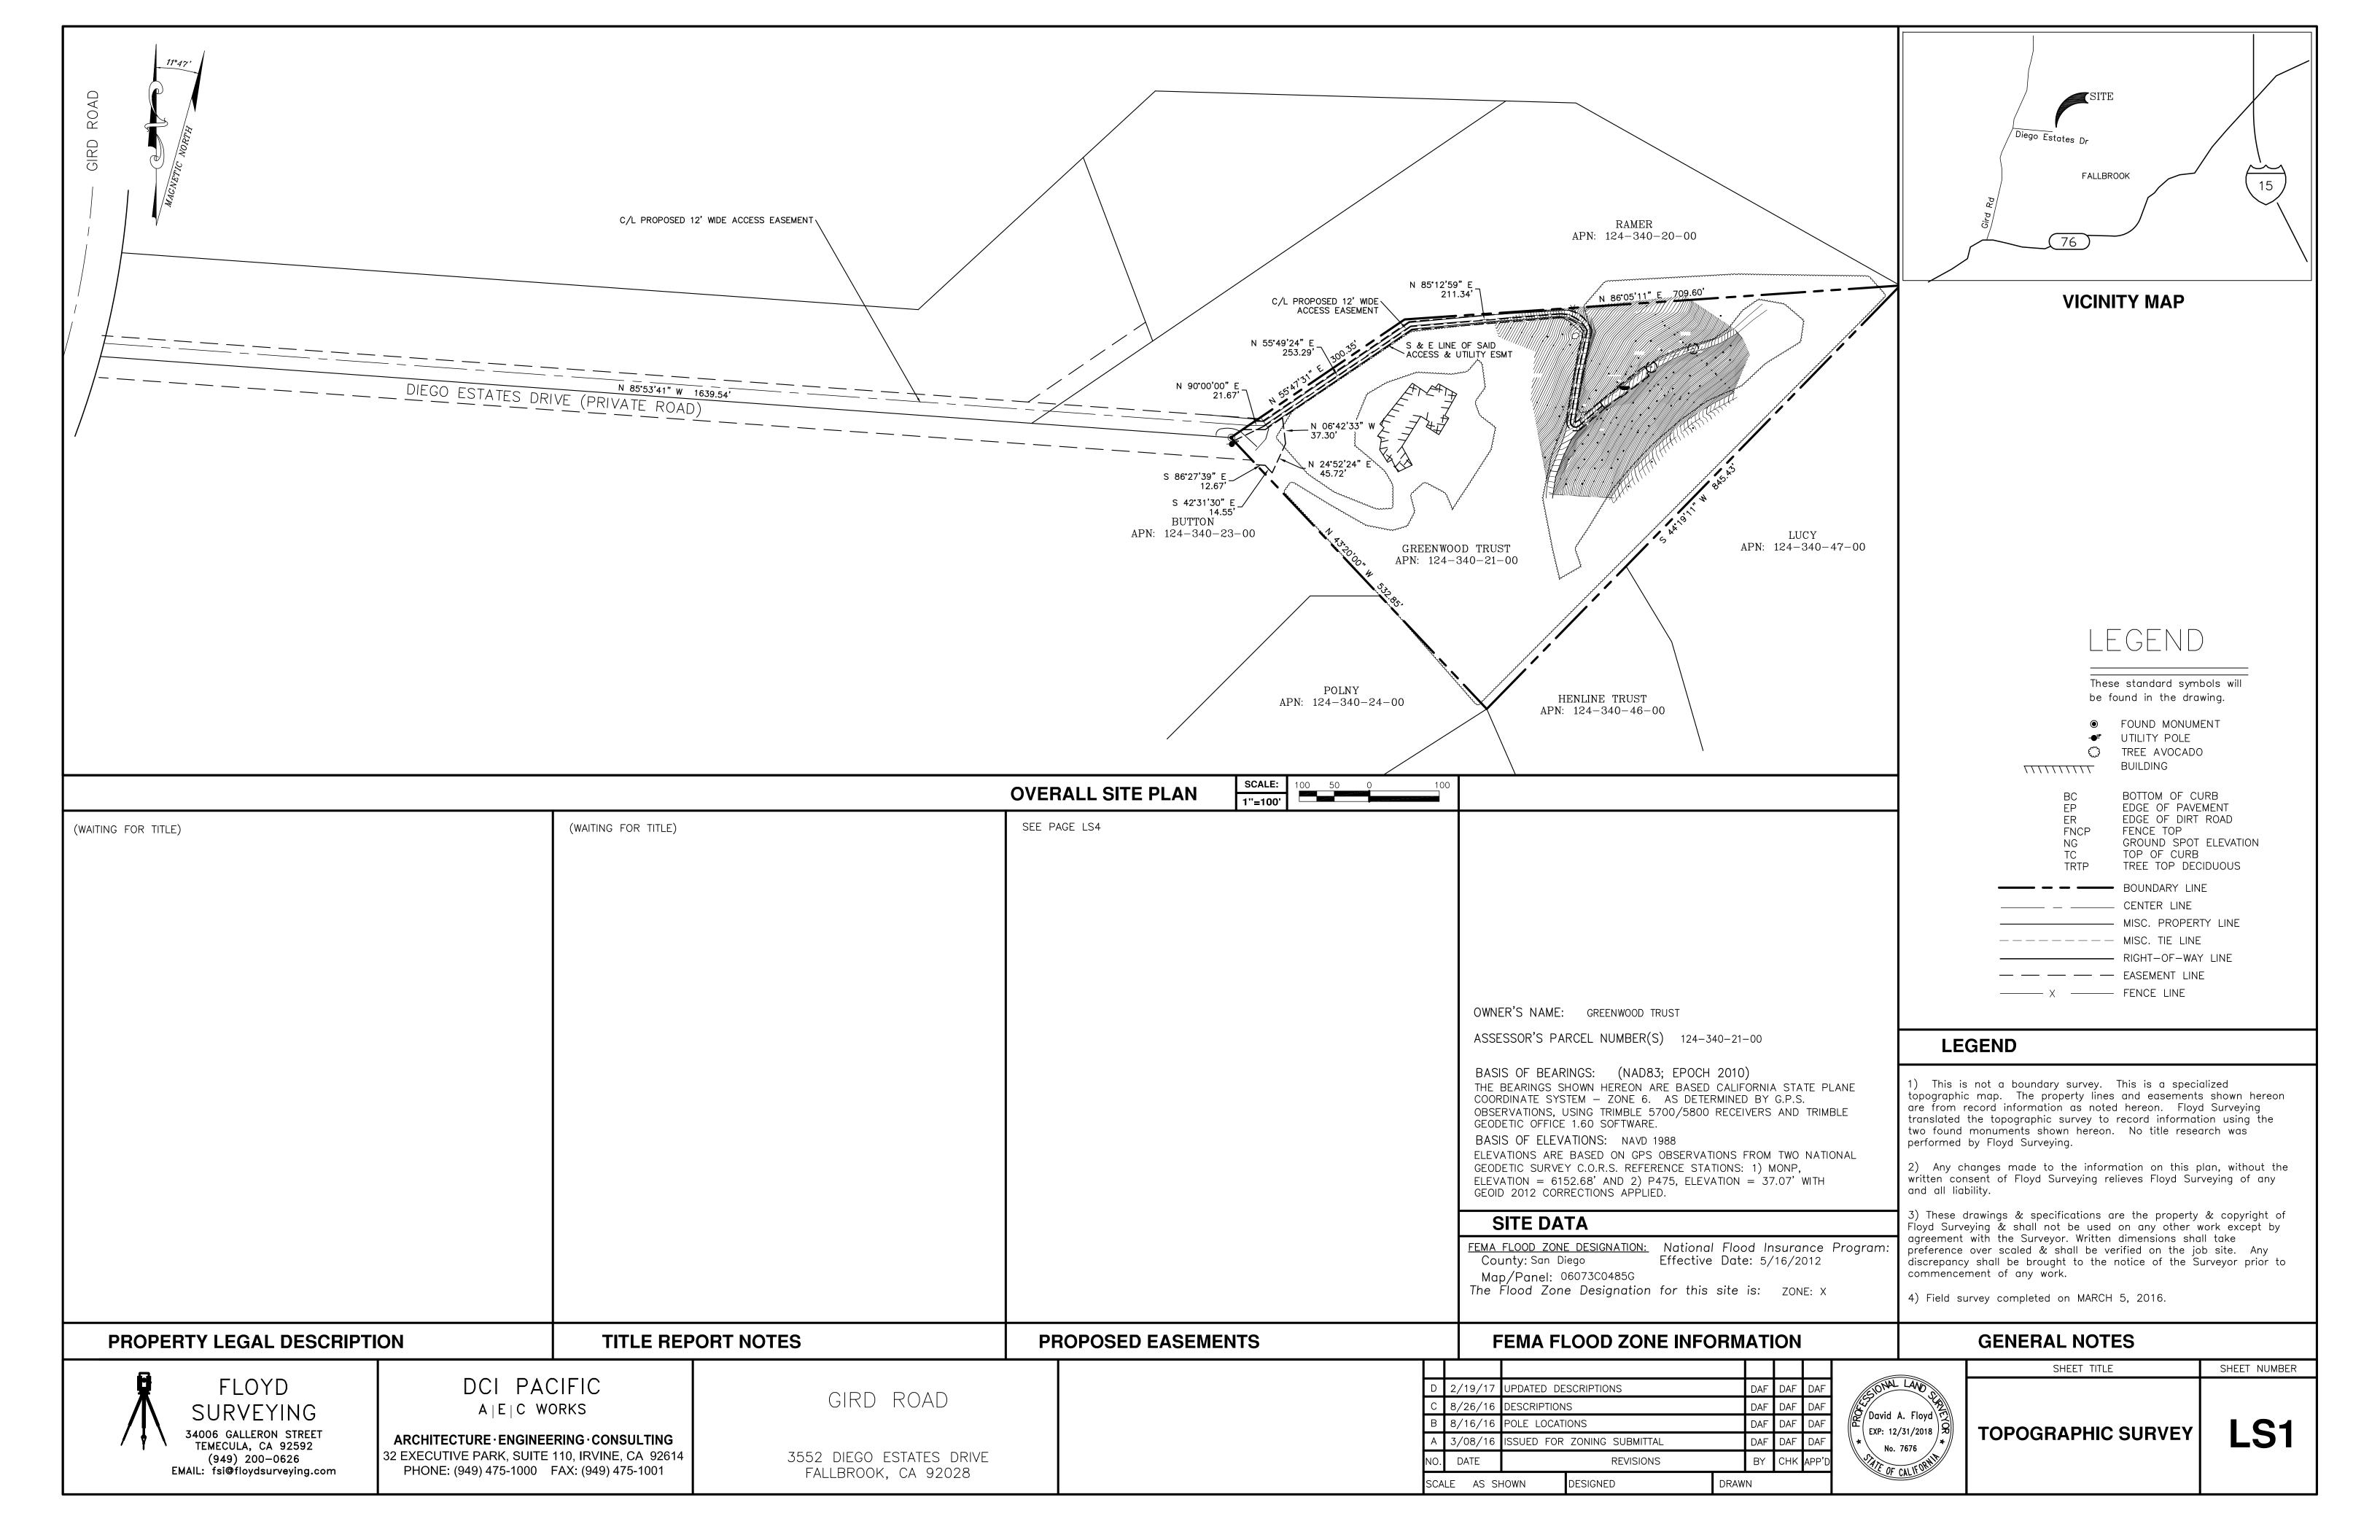

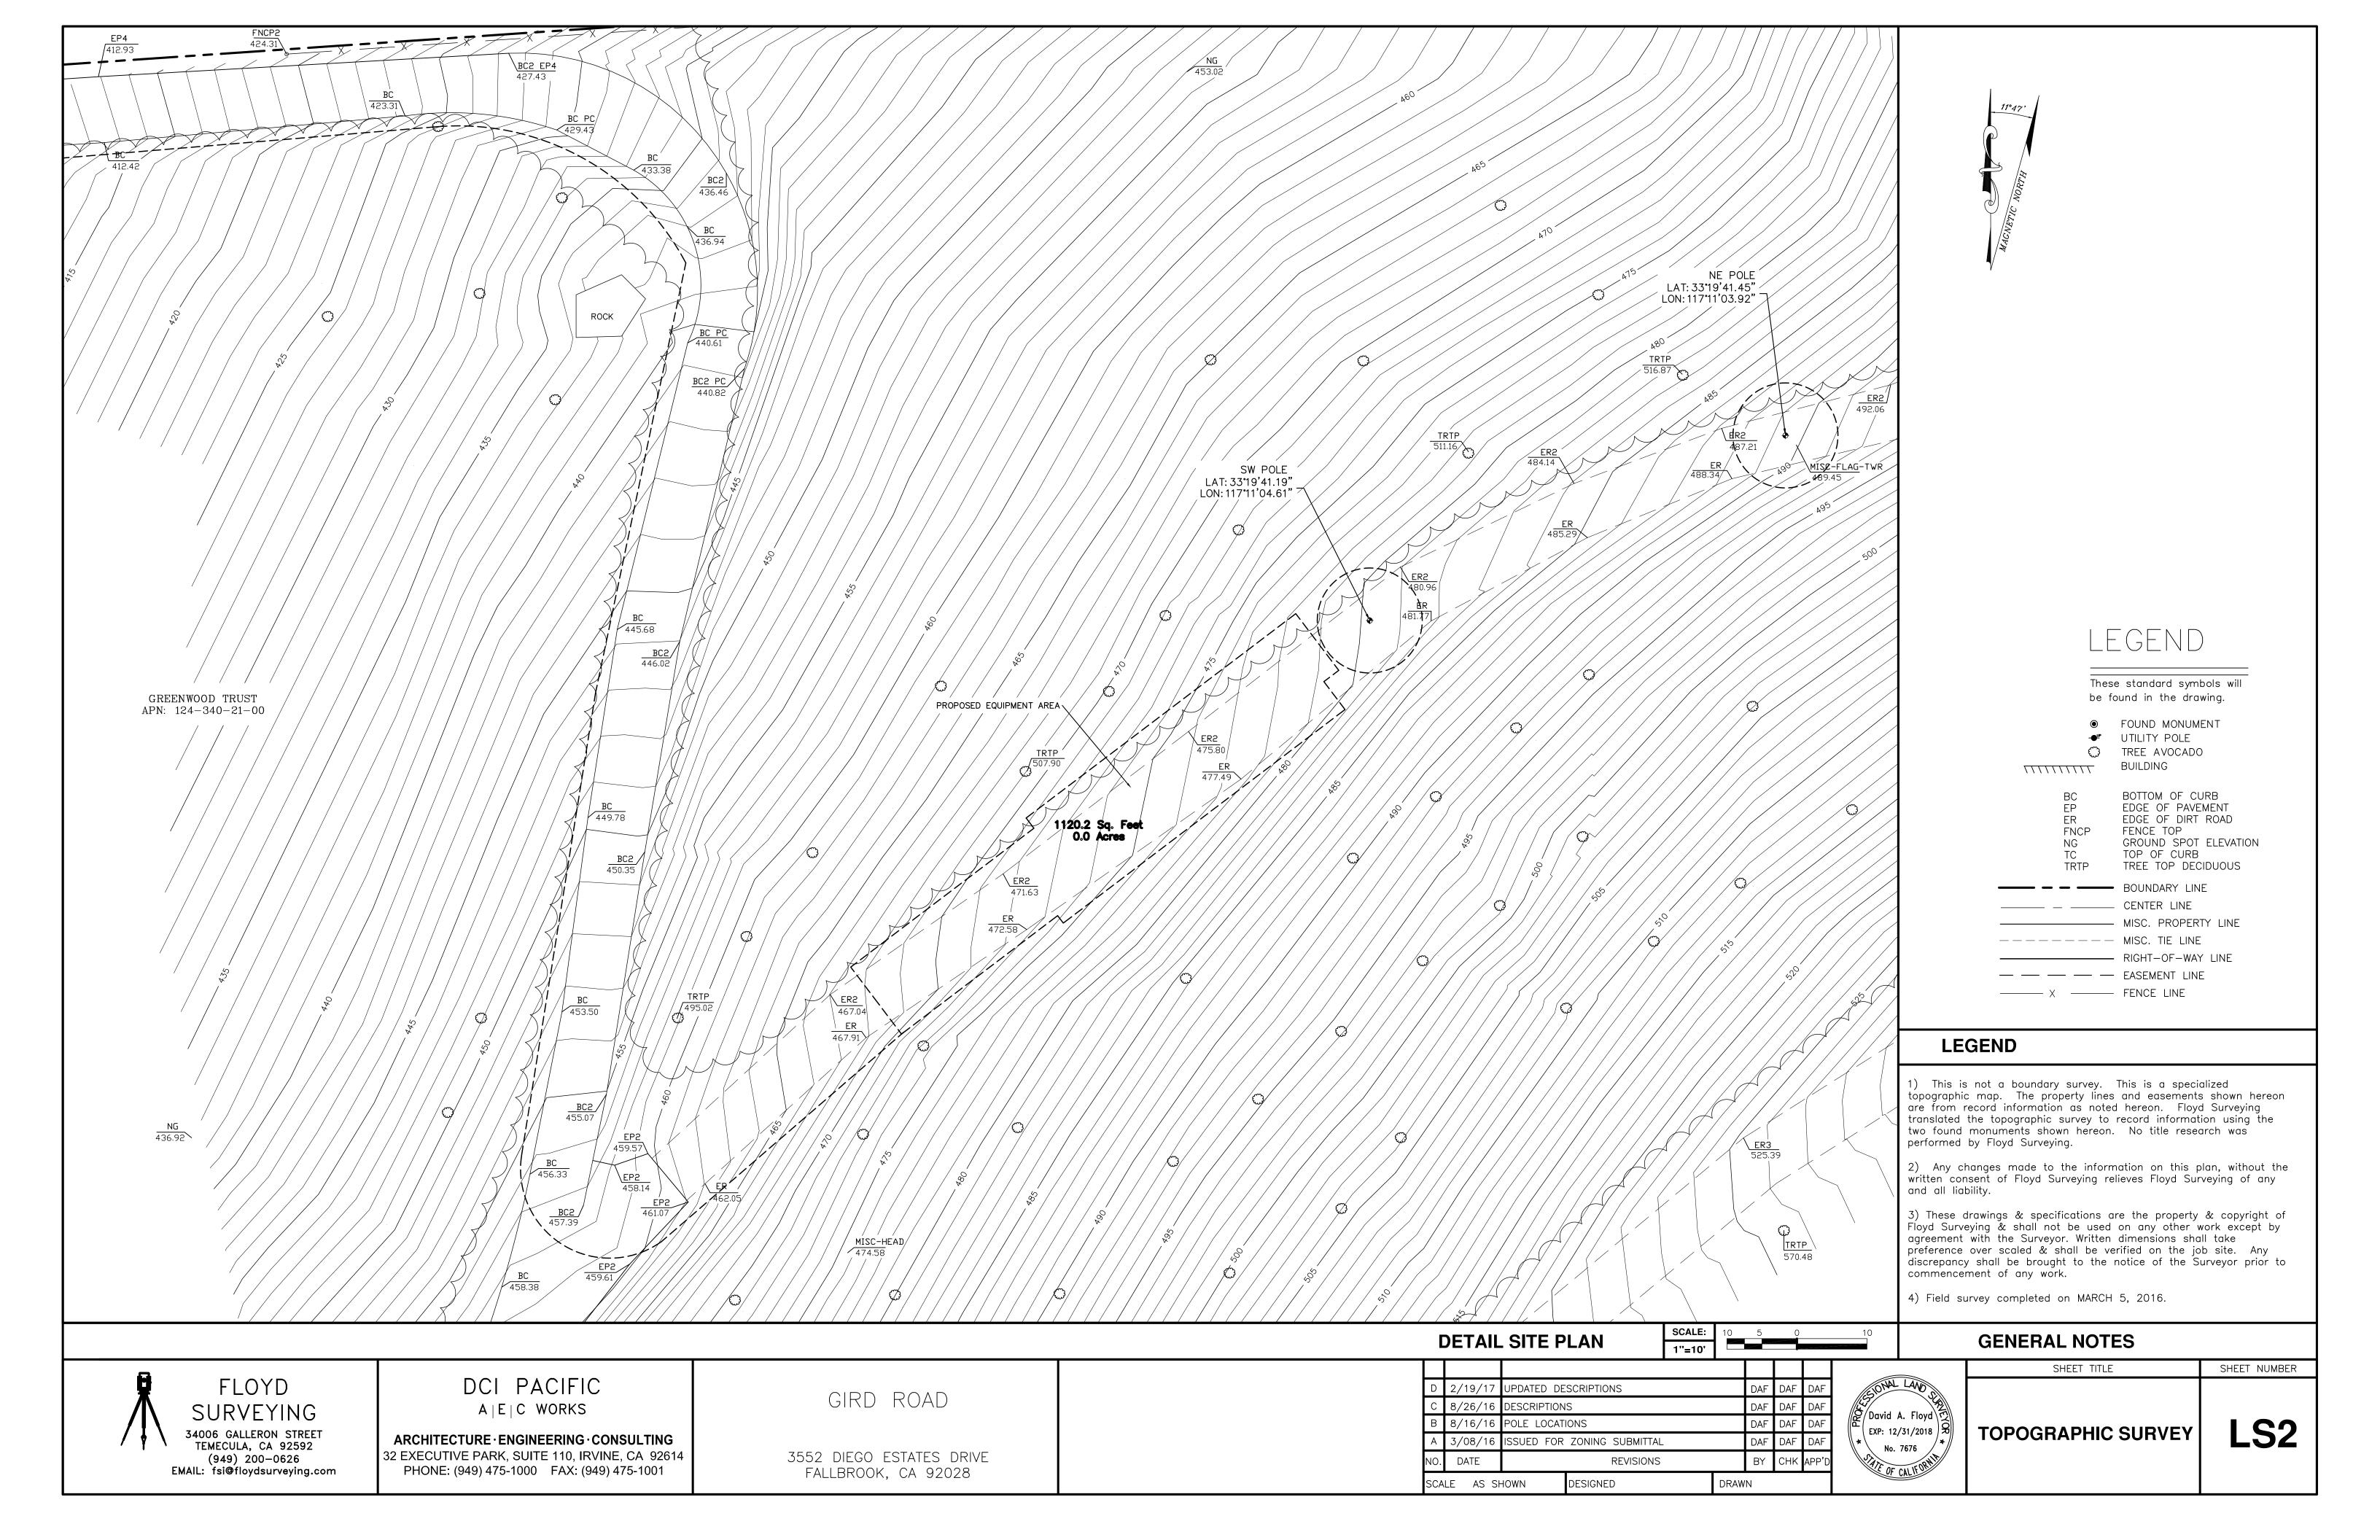

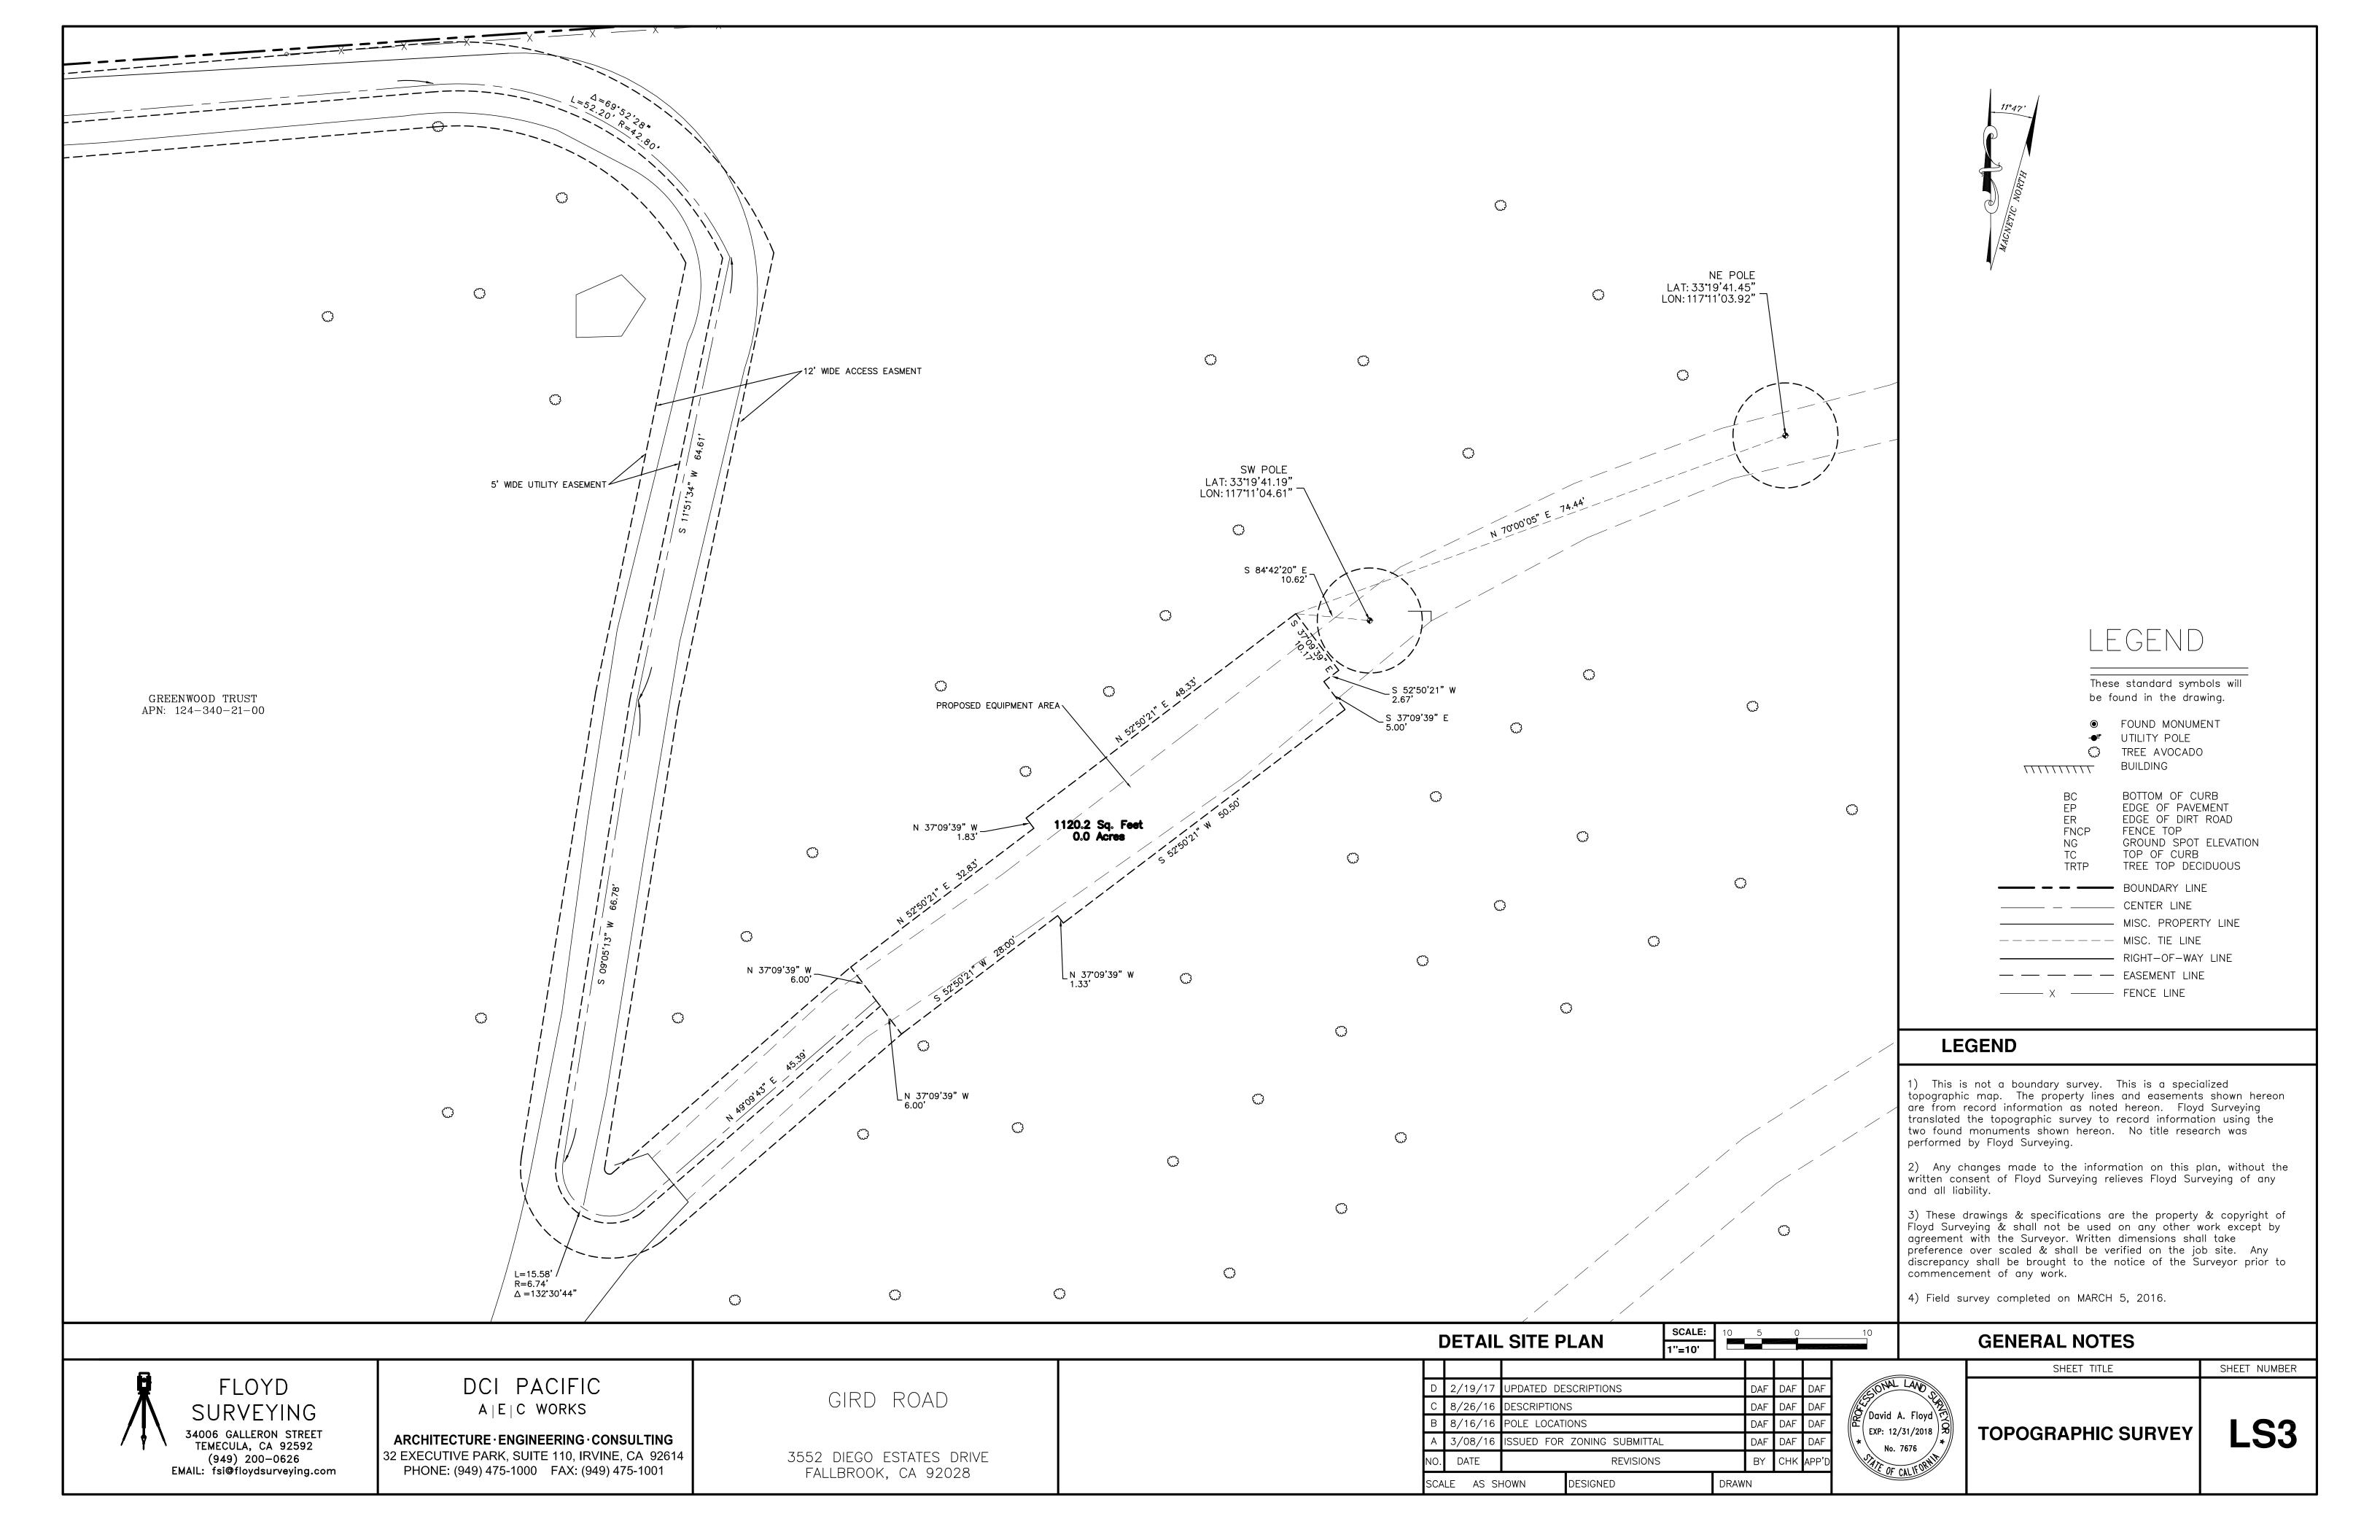

ACCESS EASEMENT:

AN EASEMENT FOR INGRESS AND EGRESS OVER A STRIP OF LAND 12.00 FEET WIDE, OVER A PORTION OF PARCEL 4 OF PARCEL MAP NO. 4269, IN THE COUNTY OF SAN DIEGO, STATE OF CALIFORNIA, FILED IN THE OFFICE OF THE COUNTY RECORDER OF SAN DIEGO COUNTY, NOVEMBER 28, 1975 AS FILE NO. 75–335571 OF OFFICIAL RECORDS, THE CENTERLINE BEING DESCRIBED AS FOLLOWS:

COMMENCING AT THE MOST WESTERLY CORNER OF SAID PARCEL 4; THENCE ALONG THE NORTHWEST LINE OF SAID PARCEL 4, NORTH 55°47′31″ EAST, A DISTANCE OF 30.99 FEET TO THE POINT OF BEGINNING; THENCE, EAST, A DISTANCE OF 21.67 FEET; THENCE, NORTH 55°49′24″ EAST, A DISTANCE OF 253.29 FEET; THENCE, NORTH 85°12′59″ EAST, A DISTANCE OF 211.34 FEET TO THE BEGINNING OF A CURVE CONCAVING TO THE SOUTHWEST WITH A RADIUS OF 42.80 FEET; THENCE SOUTHEASTERLY ALONG SAID CURVE A DISTANCE OF 52.20 FEET AND THROUGH A CENTRAL ANGLE OF 69°52′28″; THENCE, NON—TANGENT TO SAID CURVE SOUTH 11°51′34″ WEST, A DISTANCE OF 64.61 FEET; THENCE, SOUTH 09°05′13″ WEST, A DISTANCE OF 66.78 FEET TO THE BEGINNING OF A CURVE CONCAVING TO THE NORTH WITH A RADIUS OF 6.74 FEET; THENCE, SOUTH & NORTHEAST ALONG SAID CURVE A DISTANCE OF 15.58 FEET AND THROUGH A CENTRAL ANGLE OF 132°30′44″; THENCE, NON—TANGENT TO SAID CURVE NORTH 49°09′43″ EAST, A DISTANCE OF 45.39 FEET TO A POINT HEREIN AFTER KNOWN AS POINT "A", SAID POINT BEING THE POINT OF TERMINATION.

TOGETHER A STRIP OF LAND 12.00 FEET WIDE, OVER A PORTION OF SAID PARCEL MAP NO. 4269, BEGINNING AT THE BEFORE MENTIONED POINT OF BEGINNING; THENCE, NORTH 85°53'41" WEST, A DISTANCE OF 1639.54 FEET TO THE POINT OF TERMINATION WHICH IS ON THE EASTERLY RIGHT—OF—WAY LINE OF GIRD ROAD.

POWER/TELCO EASEMENT:

AN EASEMENT FOR UTILITY PURPOSES OVER A STRIP OF LAND 5.00 FEET WIDE, OVER A PORTION OF SAID PARCEL 4, THE SOUTHERLY AND EASTERLY LINES OF SAID EASEMENT BEING DESCRIBED AS FOLLOWS:

COMMENCING AT THE WESTERLY CORNER OF SAID PARCEL 4; THENCE, ALONG THE SOUTHWEST LINE OF SAID PARCEL 4 SOUTH 43°20'00" EAST, A DISTANCE OF 53.29 FEET TO THE POINT OF BEGINNING OF THE SOUTHERLY/EASTERLY LINE OF SAID 5.00 FEET WIDE EASEMENT; THENCE, SOUTH 86°27'39" EAST, A DISTANCE OF 12.67 FEET; THENCE, SOUTH 42°31'30" EAST, A DISTANCE OF 14.55 FEET; THENCE, NORTH 24°52'24" EAST, A DISTANCE OF 45.72 FEET; THENCE, NORTH 06°42'33" WEST, A DISTANCE OF 37.30 FEET TO THE SOUTHERLY/EASTERLY LINE OF THE BEFORE DESCRIBED 12' WIDE ACCESS EASEMENT; THENCE, ALONG THE SOUTH/EASTERLY 12' WIDE EASEMENT UNTIL THE POINT OF TERMINATION OF SAID 12' WIDE EASEMENT.

PROPOSED EQUIPMENT AREA:

BEING A PORTION OF PARCEL 4 OF PARCEL MAP NO. 4269, IN THE COUNTY OF SAN DIEGO, STATE OF CALIFORNIA, FILED IN THE OFFICE OF THE COUNTY RECORDER OF SAN DIEGO COUNTY, NOVEMBER 28, 1975 AS FILE NO. 75-335571 OF OFFICIAL RECORDS, DESCRIBED AS FOLLOWS:

BEGINNING AT THE BEFORE MENTIONED POINT "A"; THENCE THE FOLLOWING 11 COURSES:

- 1) NORTH 37°09'39" WEST, A DISTANCE OF 6.00 FEET; THENCE,
- 2) NORTH 52°50'21" EAST, A DISTANCE OF 32.83 FEET; THENCE,
- 3) NORTH 32 30 21 EAST, A DISTANCE OF 32.83 FEET, THENCE,
- 4) NORTH 52°50'21" EAST, A DISTANCE OF 48.33 FEET TO A POINT HEREIN AFTER KNOWN AS POINT "B": THENCE.
- 5) SOUTH 37°09'39" EAST, A DISTANCE OF 10.17 FEET; THENCE,
- 6) SOUTH 52°50'21" WEST, A DISTANCE OF 2.67 FEET; THENCE,
- 7) SOUTH 37°09'39" EAST, A DISTANCE OF 5.00 FEET; THENCE, 8) SOUTH 52°50'21" WEST, A DISTANCE OF 50.50 FEET; THENCE,
- 9) NORTH 37°09'39" WEST, A DISTANCE OF 1.33 FEET; THENCE,
- 10) SOUTH 52°50'21" WEST, A DISTANCE OF 28.00 FEET; THENCE,
- 11) NORTH 37°09'39" WEST, A DISTANCE OF 6.00 FEET TO THE POINT OF BEGINNING.

CONTAINING 1120 SQUARE FEET, MORE OR LESS.

SOUTHWEST POLE EASEMENT:

AN EASEMENT FOR TELECOMMUNITCATION POLE PURPOSES OVER A STRIP OF LAND 14.00 FEET WIDE IN DIAMETER, OVER A PORTION OF SAID PARCEL 4, THE RADIUS POINT OF SAID EASEMENT BEING DESCRIBED AS FOLLOWS:

COMMENCING AT THE BEFORE MENTIONED POINT "B"; THENCE, SOUTH 84°42'20" EAST, A DISTANCE OF 10.62 FEET TO SAID CENTER OF SAID 14.00 FEET DIAMETER EASEMENT.

NORTHEAST POLE EASEMENT:

AN EASEMENT FOR TELECOMMUNITCATION POLE PURPOSES OVER A STRIP OF LAND 14.00 FEET WIDE IN DIAMETER, OVER A PORTION OF SAID PARCEL 4, THE RADIUS POINT OF SAID EASEMENT BEING DESCRIBED AS FOLLOWS:

COMMENCING AT THE BEFORE MENTIONED POINT "B"; THENCE, NORTH 70°00'05" EAST, A DISTANCE OF 74.44 FEET TO SAID CENTER OF SAID 14.00 FEET DIAMETER EASEMENT.

SUBJECT TO COVENANTS, CONDITIONS, RESERVATIONS, RESTRICTIONS, RIGHTS OF WAY AND EASEMENTS OF RECORD, IF ANY.



_EGEND

These standard symbols will be found in the drawing.

FOUND MONUMENT
UTILITY POLE
TREE AVOCADO
BUILDING

BC BOTTOM OF CURB
EP EDGE OF PAVEMENT
ER EDGE OF DIRT ROAD
FNCP FENCE TOP
NG GROUND SPOT ELEVATION
TC TOP OF CURB
TRTP TREE TOP DECIDUOUS

BOUNDARY LINE
CENTER LINE

— X — FENCE LINE

LEGEND

- 1) This is not a boundary survey. This is a specialized topographic map. The property lines and easements shown hereon are from record information as noted hereon. Floyd Surveying translated the topographic survey to record information using the two found monuments shown hereon. No title research was performed by Floyd Surveying.
- 2) Any changes made to the information on this plan, without the written consent of Floyd Surveying relieves Floyd Surveying of any and all liability.
- 3) These drawings & specifications are the property & copyright of Floyd Surveying & shall not be used on any other work except by agreement with the Surveyor. Written dimensions shall take preference over scaled & shall be verified on the job site. Any discrepancy shall be brought to the notice of the Surveyor prior to commencement of any work.
- 4) Field survey completed on MARCH 5, 2016.

GENERAL NOTES

FLOYD SURVEYING 34006 GALLERON STREET TEMECULA, CA 92592

(949) 200-0626

EMAIL: fsi@floydsurveying.com

LOYD

RVEYING

DCI PACIFIC

A | E | C WORKS

ARCHITECTURE · ENGINEERING · CONSULTING
32 EXECUTIVE PARK, SUITE 110, IRVINE, CA 92614
PHONE: (949) 475-1000 FAX: (949) 475-1001

GIRD ROAD

PROPOSED EASEMENT DESCRIPTIONS

3552 DIEGO ESTATES DRIVE FALLBROOK, CA 92028

DAF DAF DAF D 2/19/17 UPDATED DESCRIPTIONS DAF DAF DAF C 8/26/16 DESCRIPTIONS DAF DAF DAF B 8/16/16 POLE LOCATIONS DAF DAF DAF A 3/08/16 SSUED FOR ZONING SUBMITTAL BY CHK APP'[DATE REVISIONS ESIGNED DRAWN SCALE AS SHOWN



TOPOGRAPHIC SURVEY

SHEET TITLE

LS4

SHEET NUMBER